
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EXHIBIT C

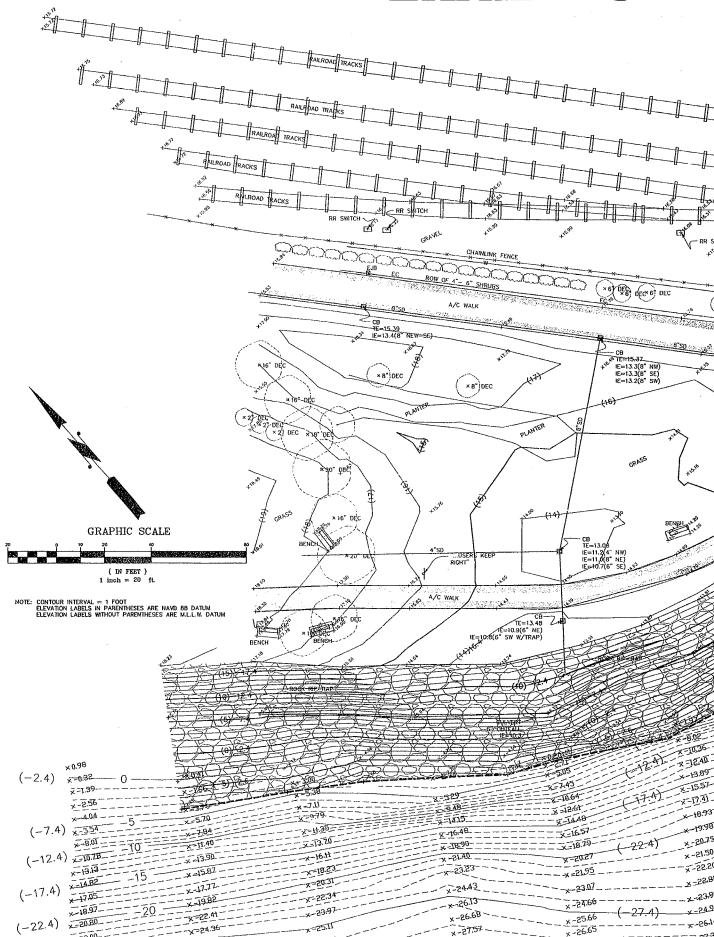



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Ondimme 121914

Olympic Sculpture of

CLERK

Seattle Art Museum Seattle, Washington 100 University Street Seattle, WA 98101

LEAD DESIGNER

Site Design / Architecture
Weiss / Manfredi Architects 130 West 29th Street
New York, NY 10001
212,760.9002

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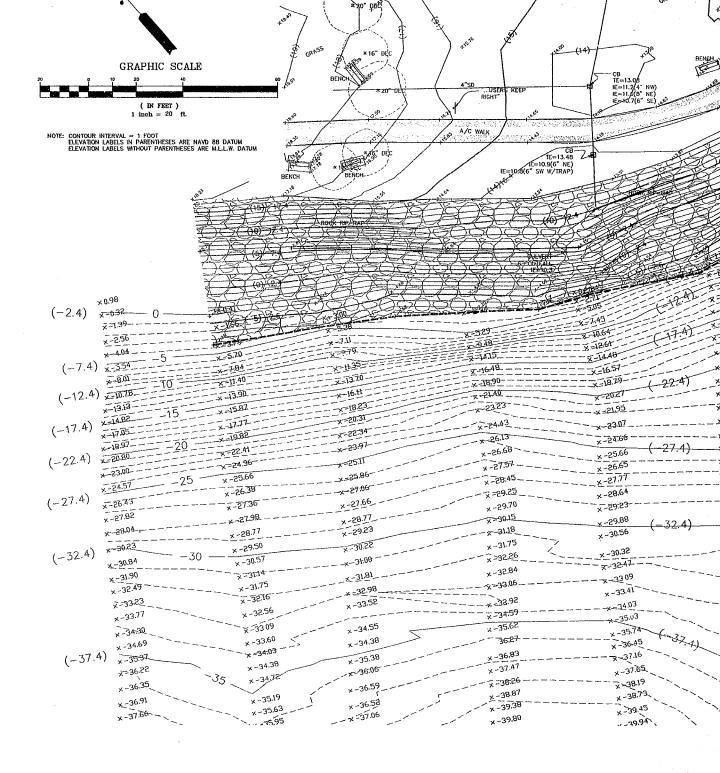
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- CB CATCH BASIN
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- CEDAR TREE SIZE AS NOTED
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- DECIDUOUS TREE SIZE AS NOTED
- Ε ELECTRICAL WIRES
- ELECTRICAL CONDUIT
- ECC EXTRUDED CONCRETE CURB
- EV ELECTRICAL VAULT
- FDC FIRE DEPARTMENT CONNECTION *- FENCE (CHAIN LINK)
- // // FENCE (WOOD)
 - FIRE HYDRANT
 - FIBER OPTICS
 - F/OV FIBER OPTICS VAULT
 - GAS LINE
 - GAS VALVE
 - GM GAS METER
 - GUY POLE
 - GUY ANCHOR
 - HH HAND HOLE

 - (6) MONITOR WELL OVERHEAD
 - PARKING METER 0
 - PLANTER

0/H

- POWER METER -O POWER POLE W/ LIGHT

- POWER VAULT
- (R) RECORD DATA



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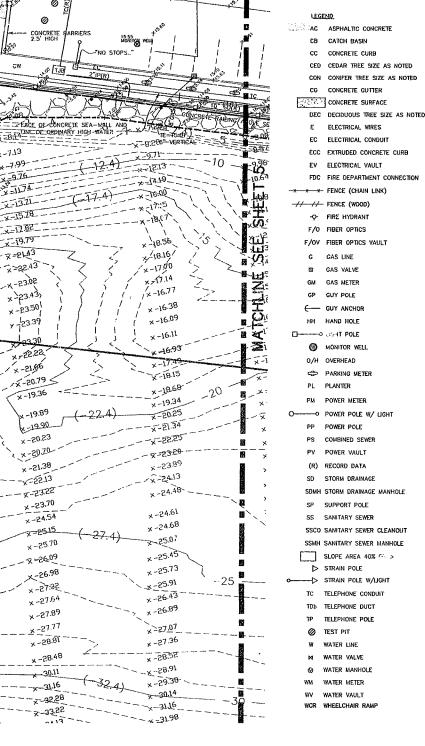




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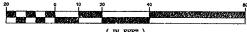
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Drawing No.

Document 50% CONSTRUCTION DOCUMENTS



GRAPHIC SCALE



(IN FEET) 1 inch = 20 ft.

NOTE: CONTOUR INTERVAL = 1 FOOT ELEVATION LABELS IN PARENTHESES ARE NAVD 88 DATUM ELEVATION LABELS WITHOUT PARENTHESES ARE M.L.L.W. DATUM

LEGEND

- AC ASPHALTIC CONCRETE
- CB CATCH BASIN
- CC CONCRETE CURB
- CED CEDAR TREE SIZE AS NOTED
- CON CONIFER TREE SIZE AS NOTED
- CG CONCRETE GUTTER

CONCRETE SURFACE


- DEC DECIDUOUS TREE SIZE AS NOTED
- ELECTRICAL WIRES
- EC ELECTRICAL CONDUIT
- ECC EXTRUDED CONCRETE CURB
- EV ELECTRICAL VAULT
- FDC FIRE DEPARTMENT CONNECTION --- FENCE (CHAIN LINK)


-// FENCE (WOOD)

- -Q- FIRE HYDRANT
- F/O FIBER OPTICS
- F/OV FIBER OPTICS VAULT
- GAS LINE
- GAS VALVE
- GAS METER
 - GUY POLE GUY ANCHOR
- HH HAND HOLE

- UGHT POLE



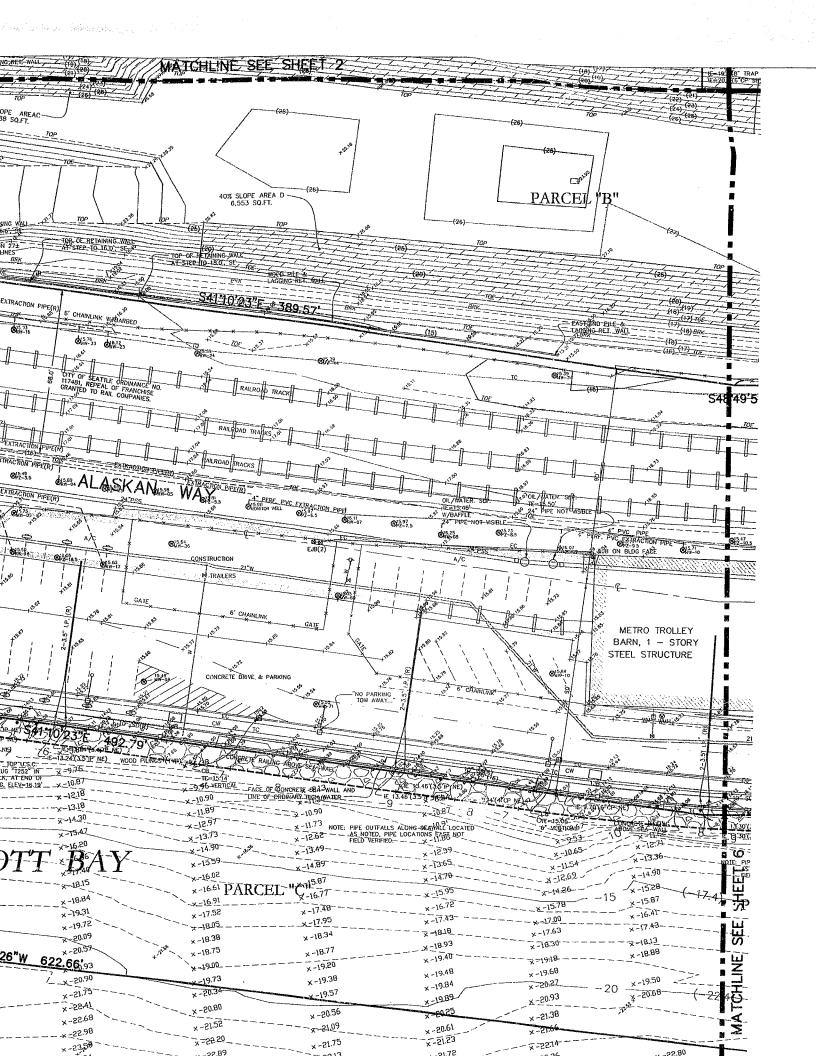

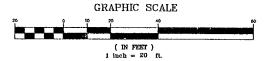

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 - F/O FIBER OPTICS
 - 4---
 - F/OV FIBER OPTICS VAULT
 - G GAS LINE
 - D GAS VALVE
 - GM GAS METER
 - GP GUY POLE
 - € GUY ANCHOR
 - HH HAND HOLE

O----O LIGHT POLE


- MONITOR WELL
- O/H OVERHEAD
- PARKING METER
- PL PLANTER
- PM POWER METER
- O POWER POLE W/ LIGHT
 PP POWER POLE
 - PS COMBINED SEWER
 - 73 COMBINED SCHOOL
 - (R) RECORD DATA
 - (R) RECORD DATA

 SD STORM DRAINAGE
 - SDMH STORM DRAINAGE MANHOLE
 - SP SUPPORT POLE
 - SS SANITARY SEWER
 - SSCO SANITARY SEWER CLEANOUT
 - SSMH SANITARY SEWER MANHOLE
- SLOPE AREA 40% OR >
 STRAIN POLE
- - TC TELEPHONE CONDUIT
 - TDb TELEPHONE DUCT
 - TP TELEPHONE POLE
 - Ø TEST PIT
 - W WATER LINE
 - M WATER VALVE

 - WM WATER METER
 - WY WATER VAULT
 - WCR WHEELCHAIR RAMP

P æ ∎IC IE=13.15'(3.5"IF 15:47.24 (3.5 IR NE) X PACHUARK E TOP U.S.C -10.84 EX-HID x=11.91 ×-12.54 x-13.52 x-44.30 x-15.47 ₩ x-14.34 ₩ × 15.02 × 16.20 × B x-15.56 -x=16.07 x-18.15 ×-16.68 ×-18.70 ×-18.84 ₩×-17.48 <u>50وب</u> x-79.31 x-19.66 X-18.18 ×-19.72 x-19.56 ×-20.23 ×-₹0.09 × 20.48 x-20.57 622.66,93 x =20.95 x-21.34 ×-51.63 _x-20.90 x-21.52 X-25:18 x-21.75 ×-22.63 x-21.66 x-28AL ×-22.84 ×=22.04 x-22.68 ×_5818 ×-22.73 ×=22.98 ×-23.40 x-23,50 ×-23.45 x-22.98 ×=23.98 4.34 ×-23.77 -24.86 x-24.23 ×-53.89 £>25.11 ×-24.00 x-25.52 x-24.41 ×-25.81 ×-24.02 ×-24.11 ×-24.09 ×-25.90 x-24.54 -26.23 ×-24.06 x-24.86 -25 x-25:40 x-26.63 **√**-25.02 x-26.00 ×-25.50 ×-26.82 x-26.25 ×-27.50 _25,95 ×-26.25 ×-5871 x-26.32 ×-27.59 ×-58.68 ×=27.05 ×-28.98 ×-27.55 ×-58.05 x-28.22 x-29.73 ×-28.25 ×-28.65 ×-30.29 ×-28.93 × -29.38 ×-30.84 x-29.32 ×>3717 x-30.63 x-29.68 ~~~32.15

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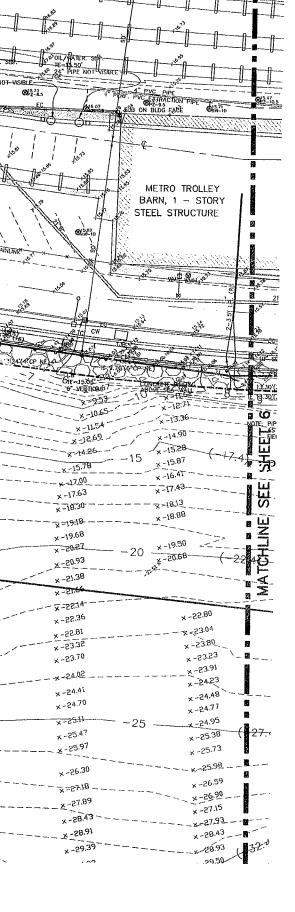
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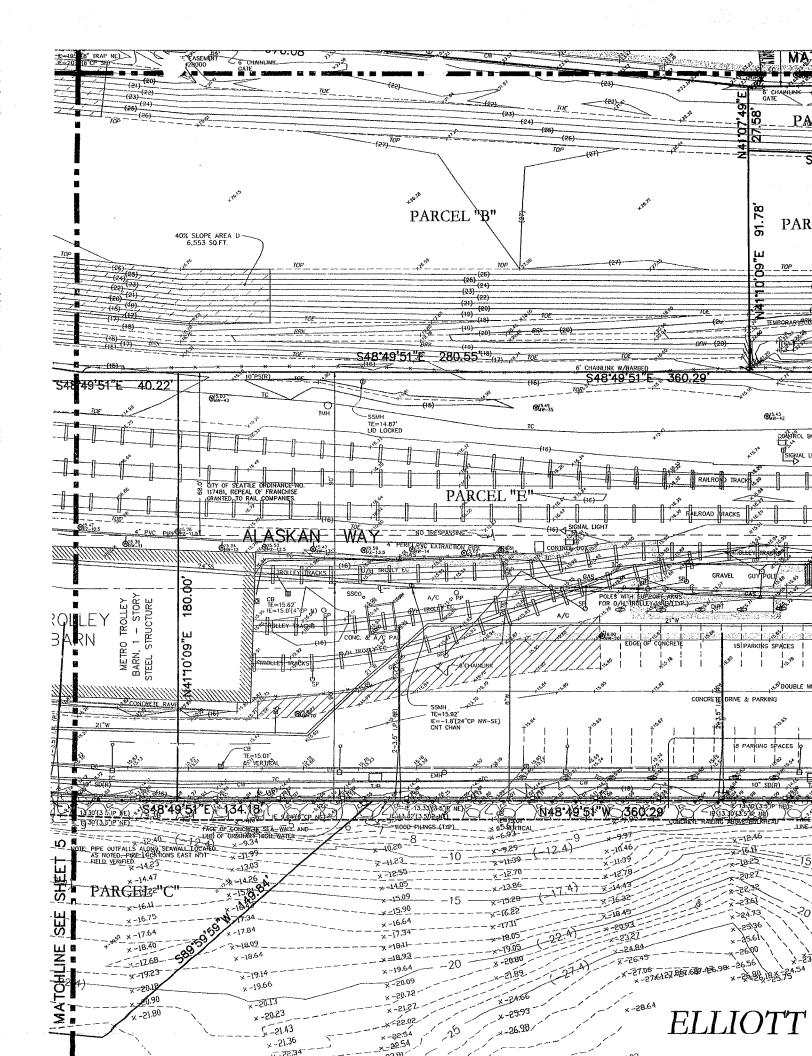
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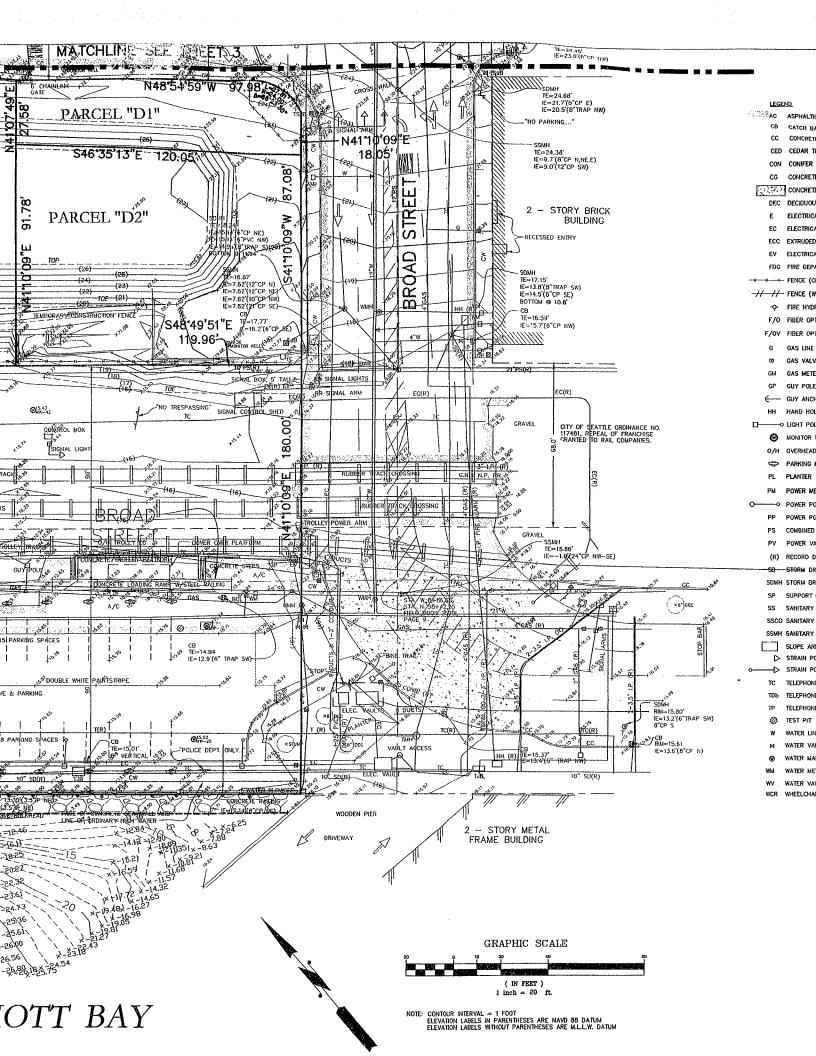
Checked DCN Scale AS NOTED

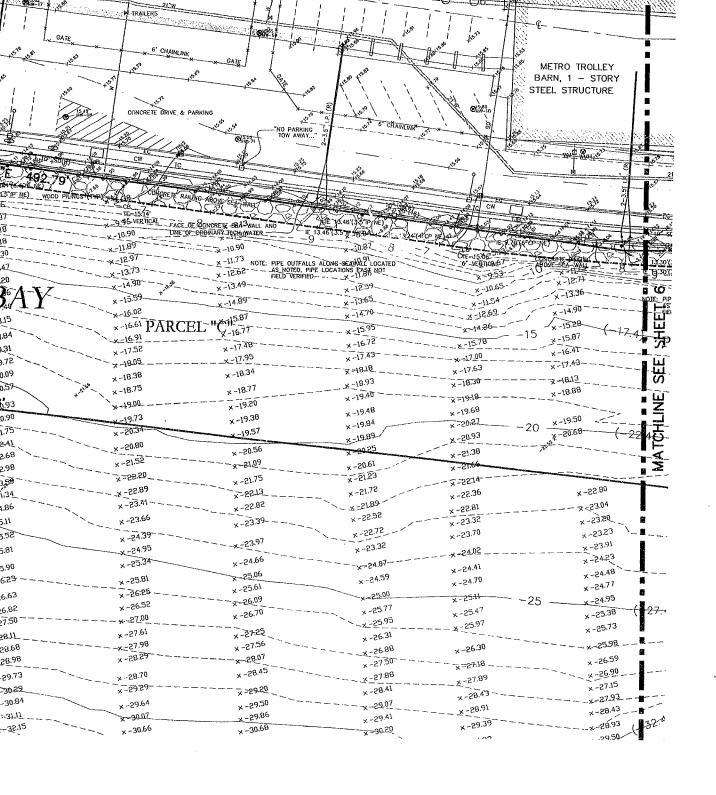Drawing No

5 OF 6

Document 50% CONSTRUCTION DOCUMENTS





4.68' .7'(6"CP E) .5'(8"TRAP NW) LEGEND AC ASPHALTIC CONCRETE CB CATCH BASIN CC CONCRETE CURB CED CEDAR TREE SIZE AS NOTED ð" 3"CP N,NE,E) 2"CP SW) CON CONIFER TREE SIZE AS NOTED CG CONCRETE GUTTER CONCRETE SURFACE DEC DECIDUOUS TREE SIZE AS NOTED ORY BRICK E ELECTRICAL WIRES BUILDING EC ELECTRICAL CONDUIT ECC EXTRUDED CONCRETE CURB EV ELECTRICAL VAULT FDC FIRE DEPARTMENT CONNECTION * FENCE (CHAIN LINK) -//-//- FENCE (WOOD) -O- FIRE HYDRANT F/O FIBER OPTICS F/OV FIBER OPTICS VAULT G GAS LINE ш GAS VALVE GM GAS METER C(R) C--- GUY ANCHOR HH HAND HOLE -O LIGHT POLE CITY OF SEATTLE ORDINANCE NO. 117481, REPEAL OF FRANCHISE GRANTED TO RAIL COMPANIES. MONITOR WELL O/H OVERHEAD PARKING METER PL PLANTER PM POWER METER - POWER POLE W/ LIGHT PP POWER POLE P5 COMBINED SEWER POWER VAULT .00 (24"CP NW-SE) (R) RECORD DATA STORM DRAINAGE SDMH STORM DRAINAGE MANHOLE SP SUPPORT POLE ×6-)DEC SS SANITARY SEWER SSCO SANITARY SEVER CLEANOUT BAR SSMH SANITARY SEWER MANHOLE STOP SLOPE AREA 40% OR > STRAIN POLE STRAIN POLE W/LIGHT TC TELEPHONE CONDUIT TELEPHONE DUCT TΡ TELEPHONE POLE IE=13.2'(6"TRAP SW) 8"CP S 0 TEST PIT 10(R) WATER LINE CB RIM=15.61 IE=13.6'(8"CP N) СĊ WATER VALVE WATER MANHOLE ww WATER METER 10" SD(R) WATER VAULT WHEELCHAIR RAMP

Olympic Sculpture Park

Seattle Art Museum Seattle, Washington 100 University Street Seattle, WA 98101

LEAD DESIGNER Site Design / Architecture Weiss / Manfredl Architects 130 West 29th Street, 12th floor New York, NY 10001 212.760.9002

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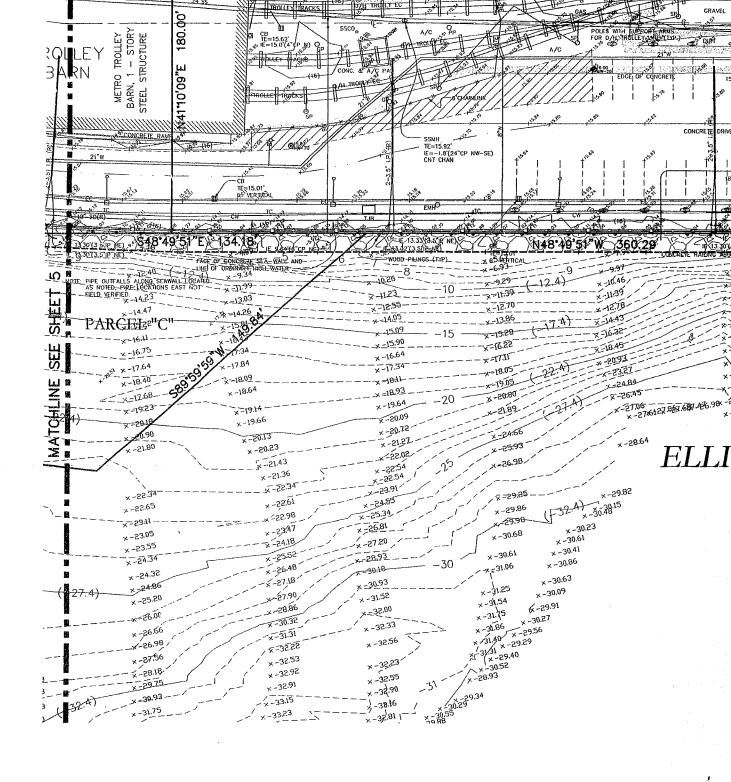
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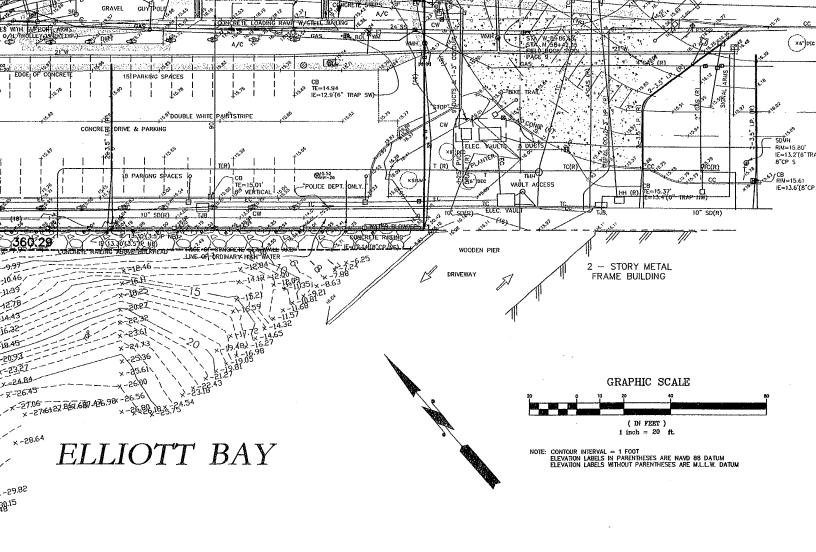
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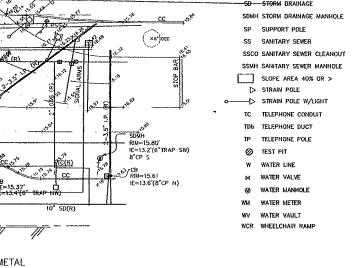
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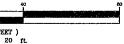








SCALE



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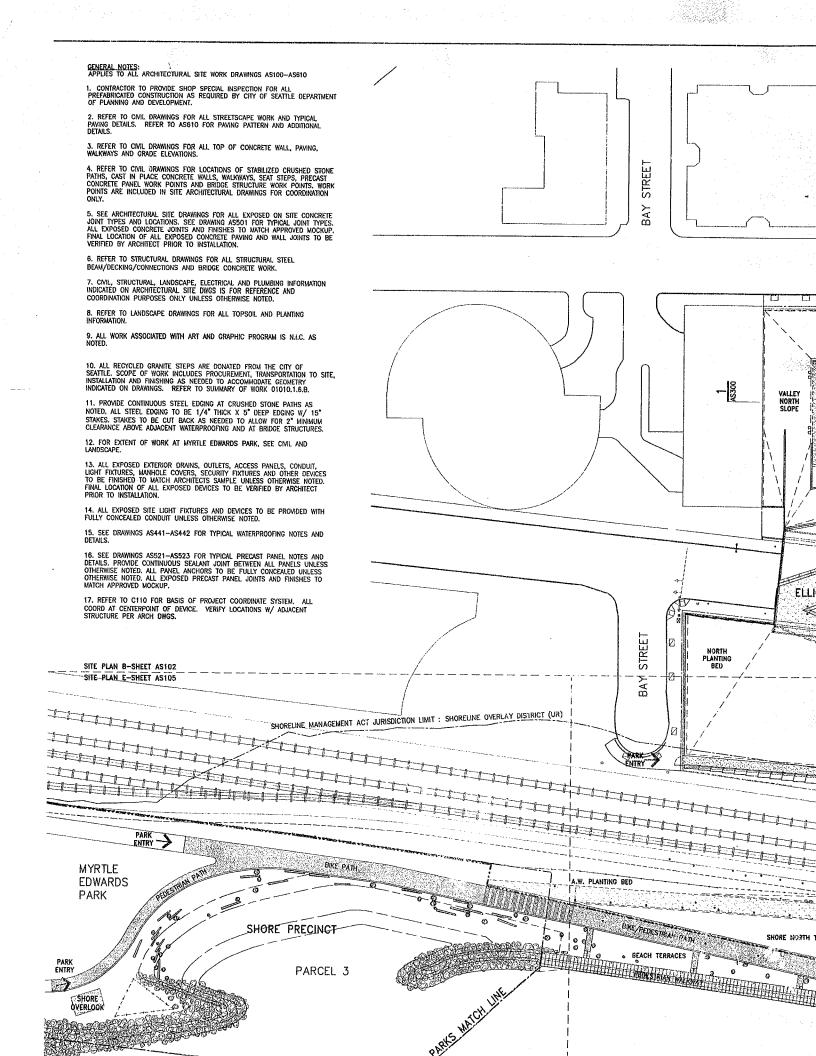
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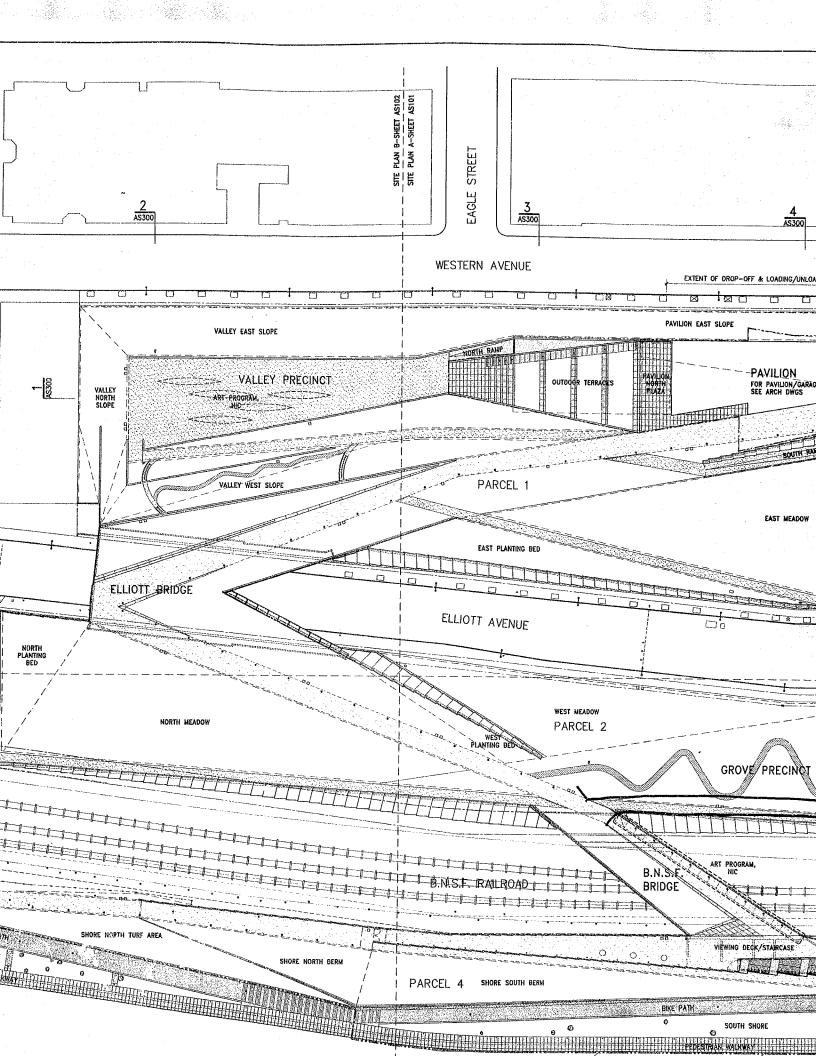
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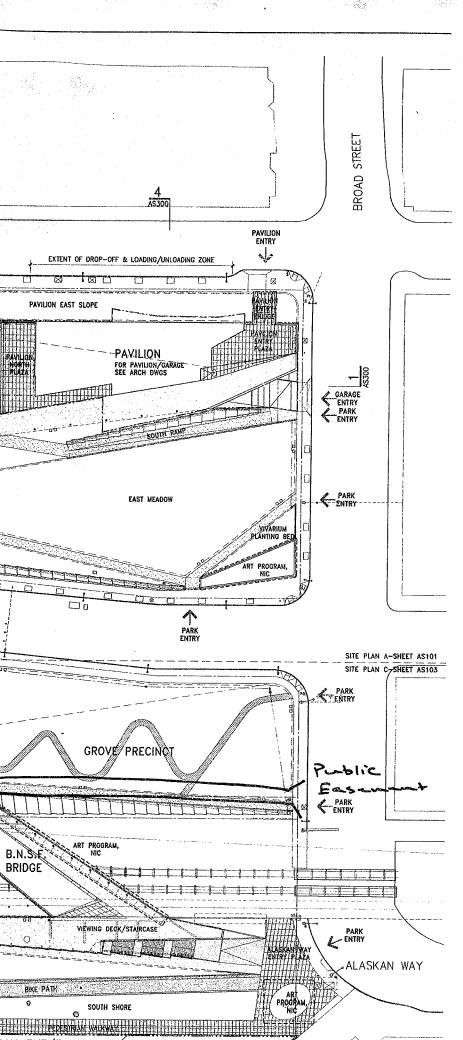
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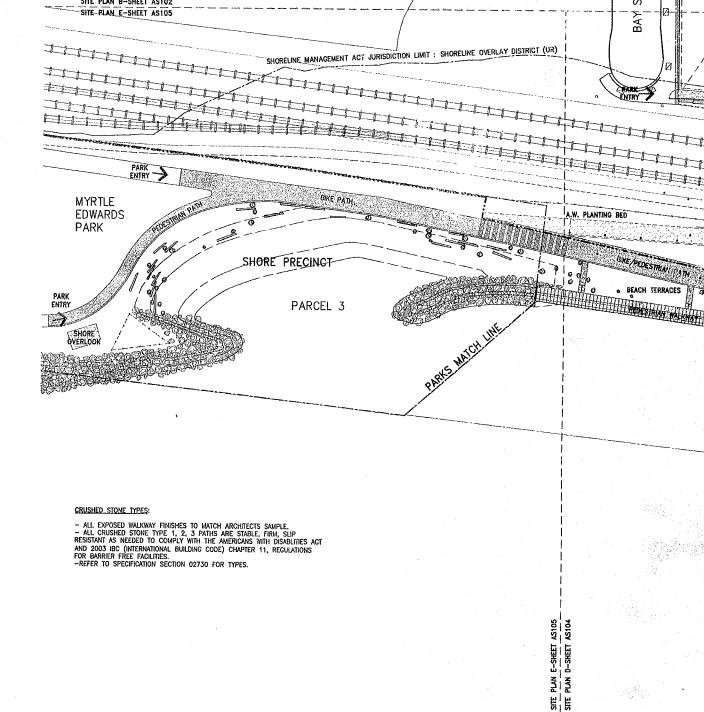
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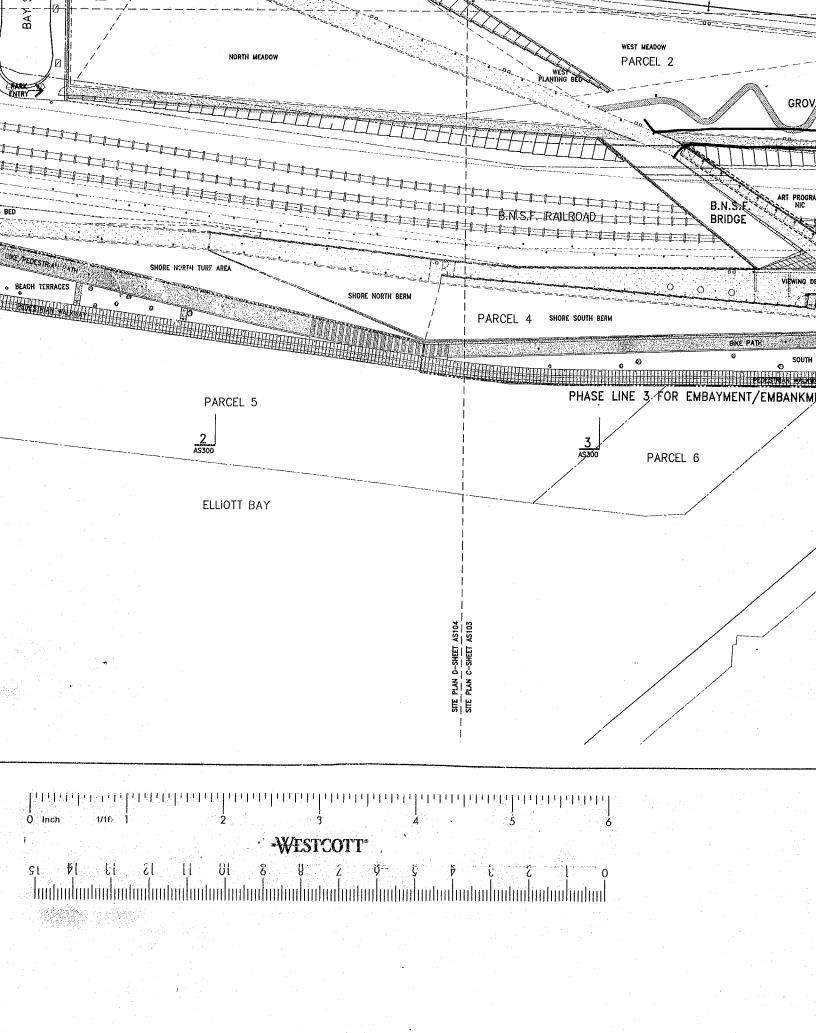
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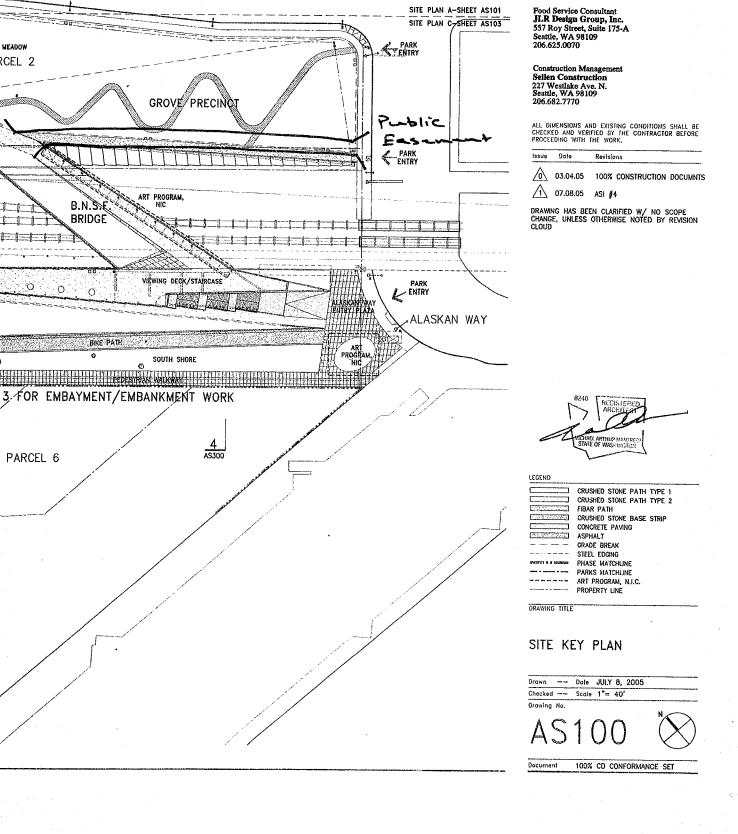
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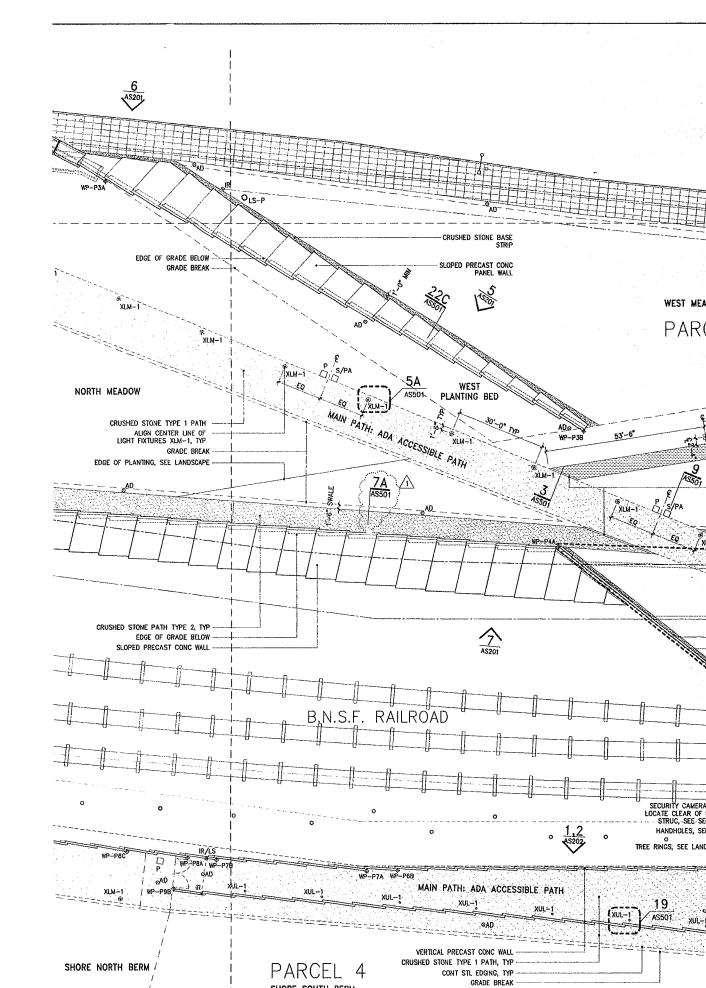



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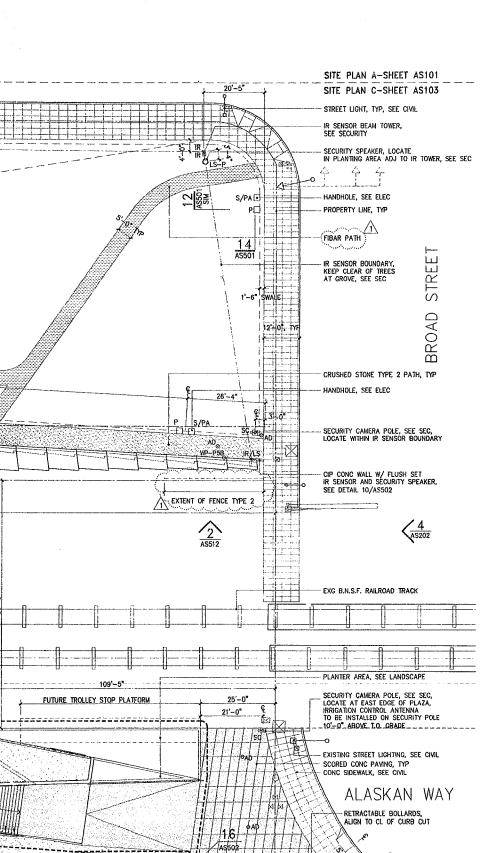
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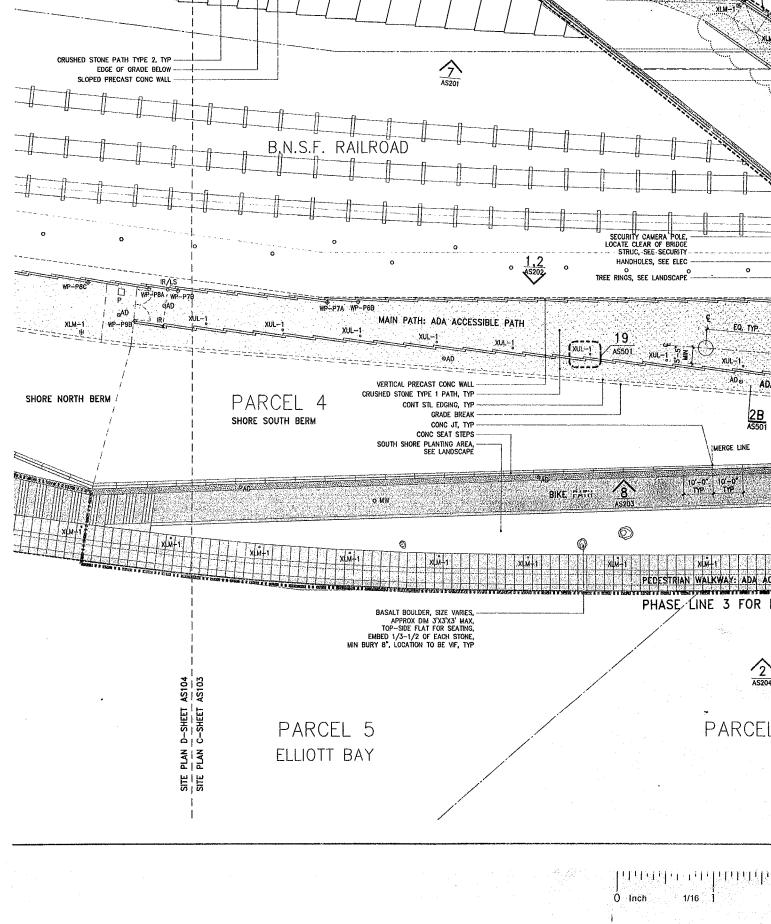
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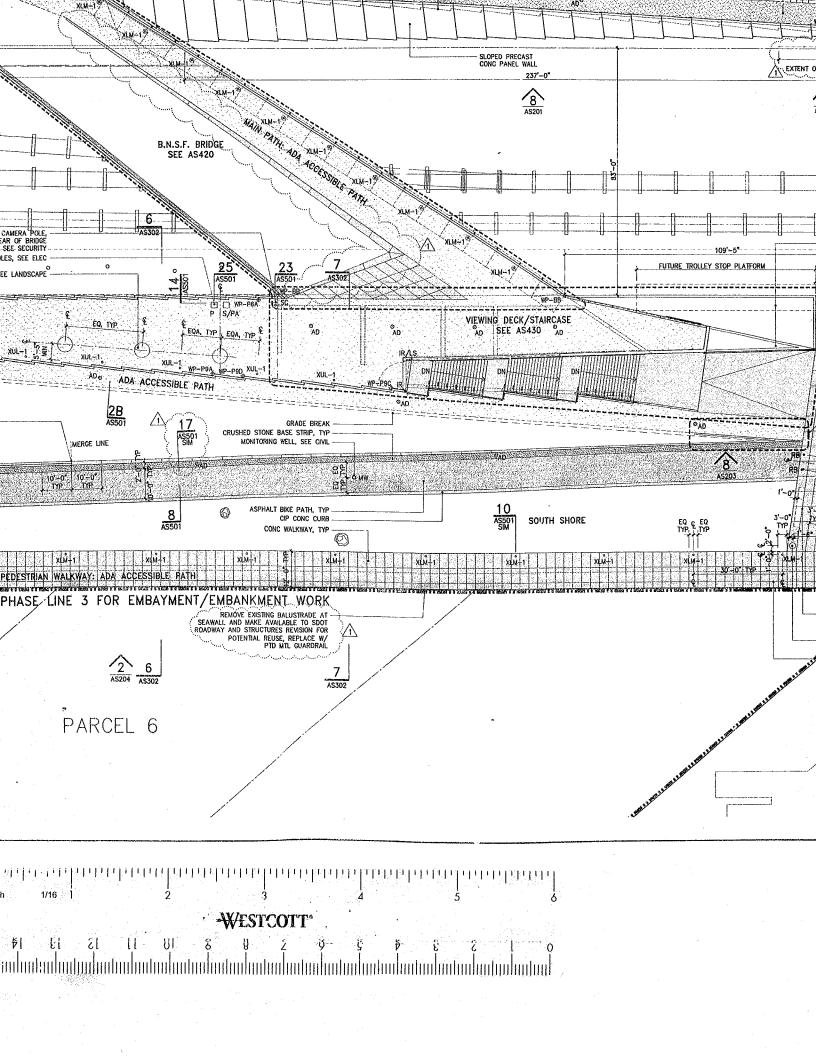
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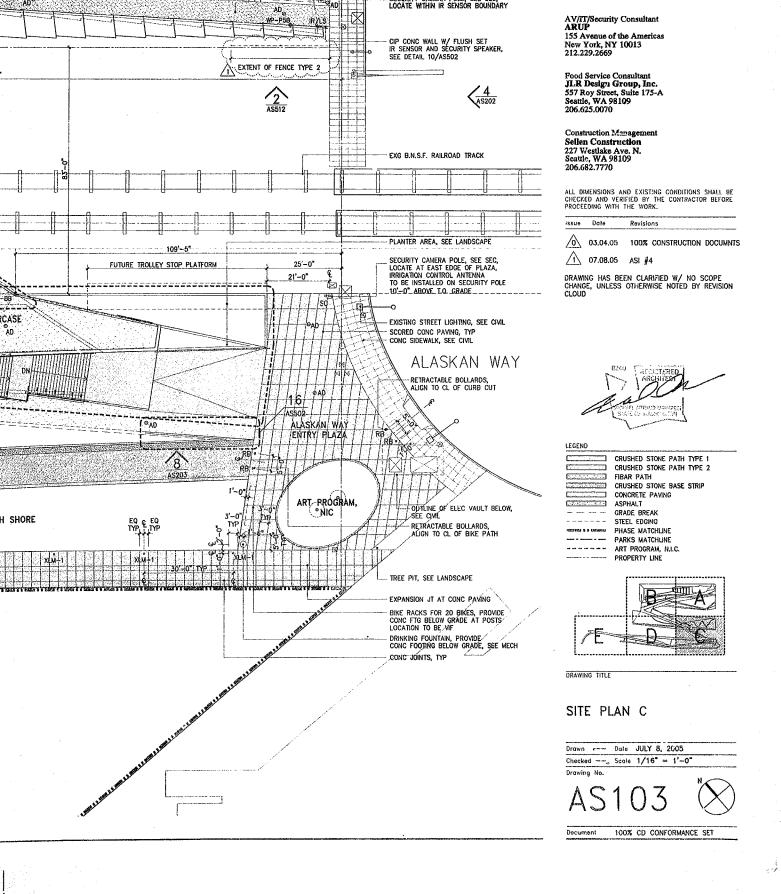
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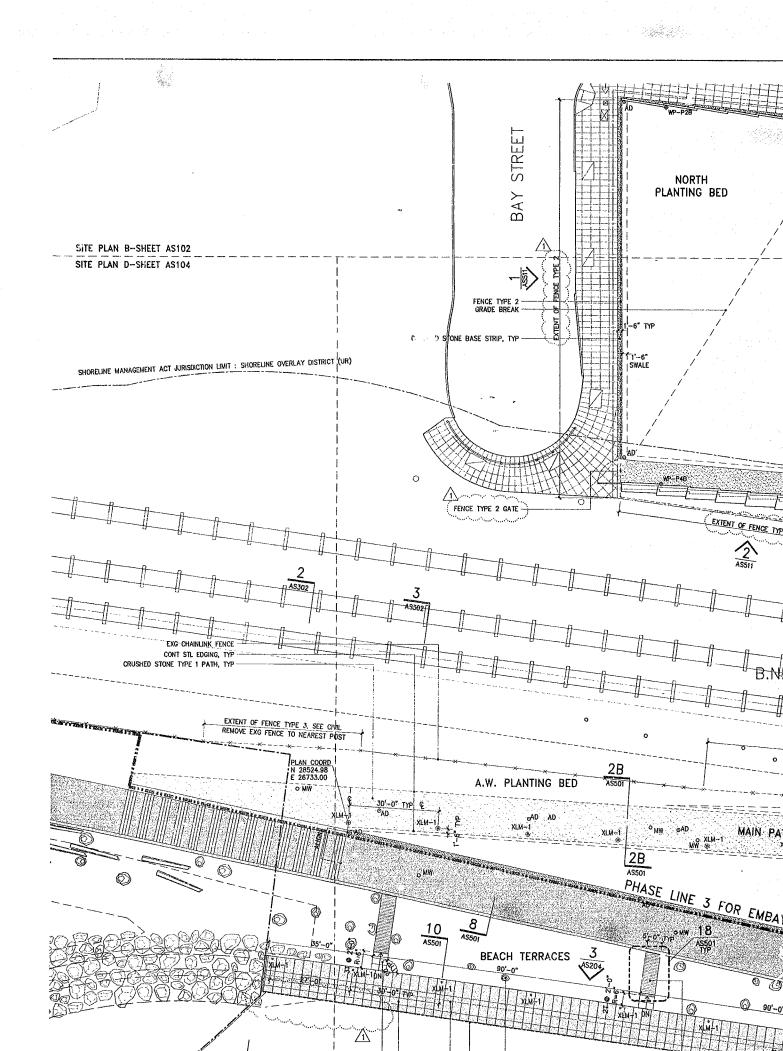
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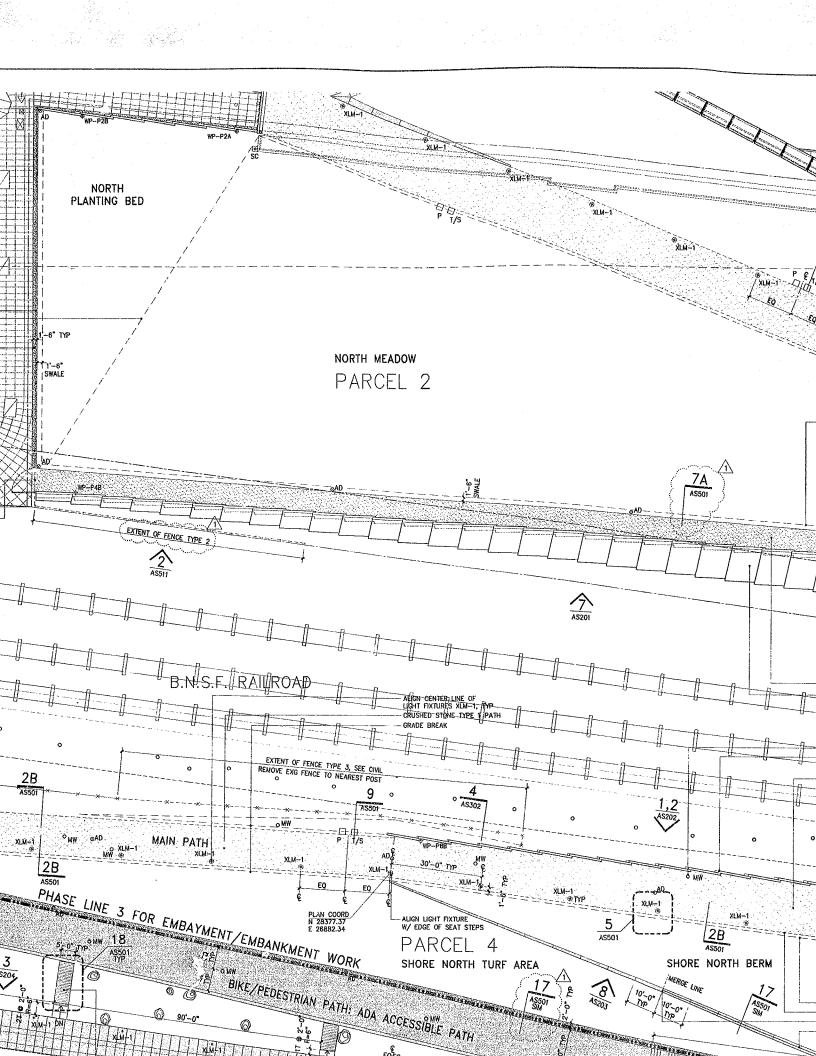



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Olympic Sculpture Park

Seattle Art Museum Seattle, Washington 100 University Street Seattle, WA 98101

LEAD DESIGNER Site Design / Architecture Weiss / Manfredl Architects 130 West 29th Street, 12th floor New York, NY 10001 212.760.9002

CONSULTANT TEAM
Structural & Civil Engineering Consultant
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Seattle, WA 98101
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Environmental Engineering Consultant Aspect Consulting 811 First Avenue, Suite 480 Seattle, WA 98104 206.838.5840

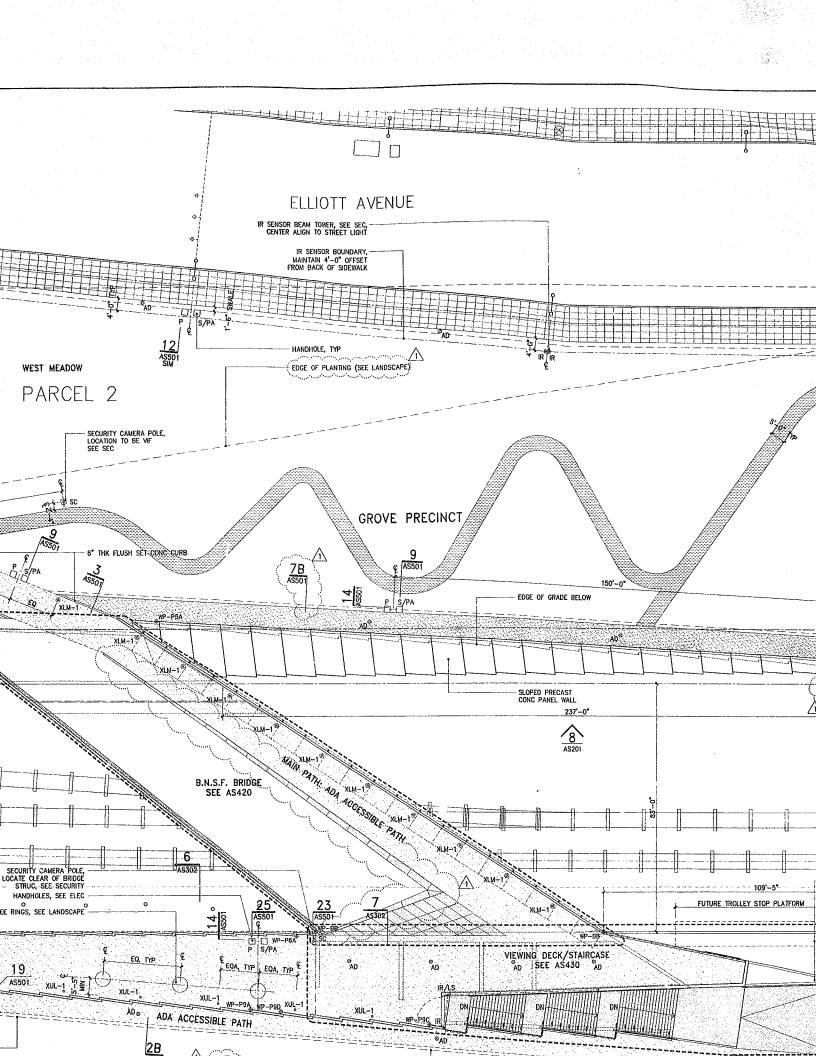Lighting Consultant Brandston Partnership, Inc. 122 West 26th Street New York, NY 10001 212.924.4050

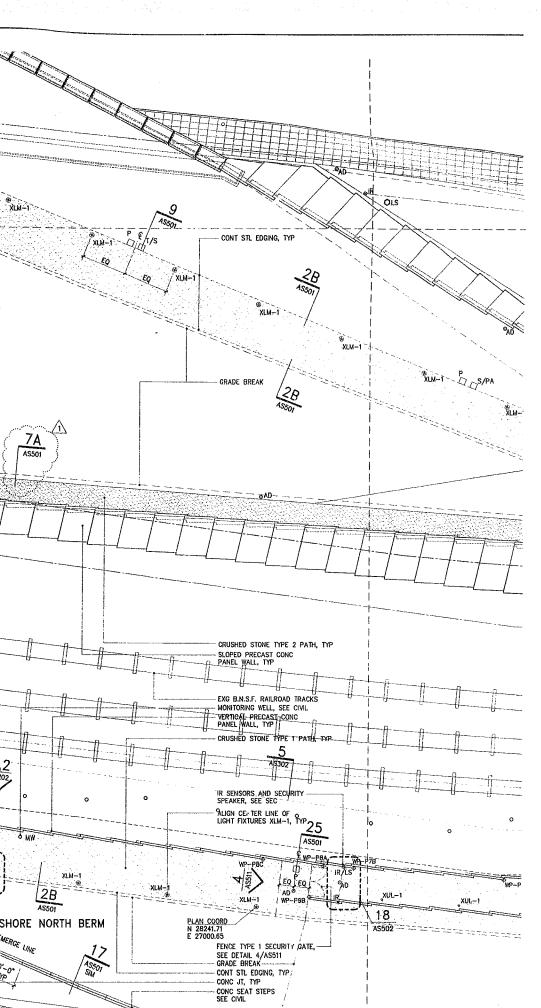AV/IT/Security Consultant ARUP 155 Avenue of the Americas New York, NY 10013 212.229.2669


Food Service Consultant JLR Design Group, Inc. 557 Roy Street, Suite 175-A Seattle, WA 98109 206.625.0070

Construction Management Sellen Construction 227 Westlake Ave. N. Seattle, WA 98109 206.682.7770

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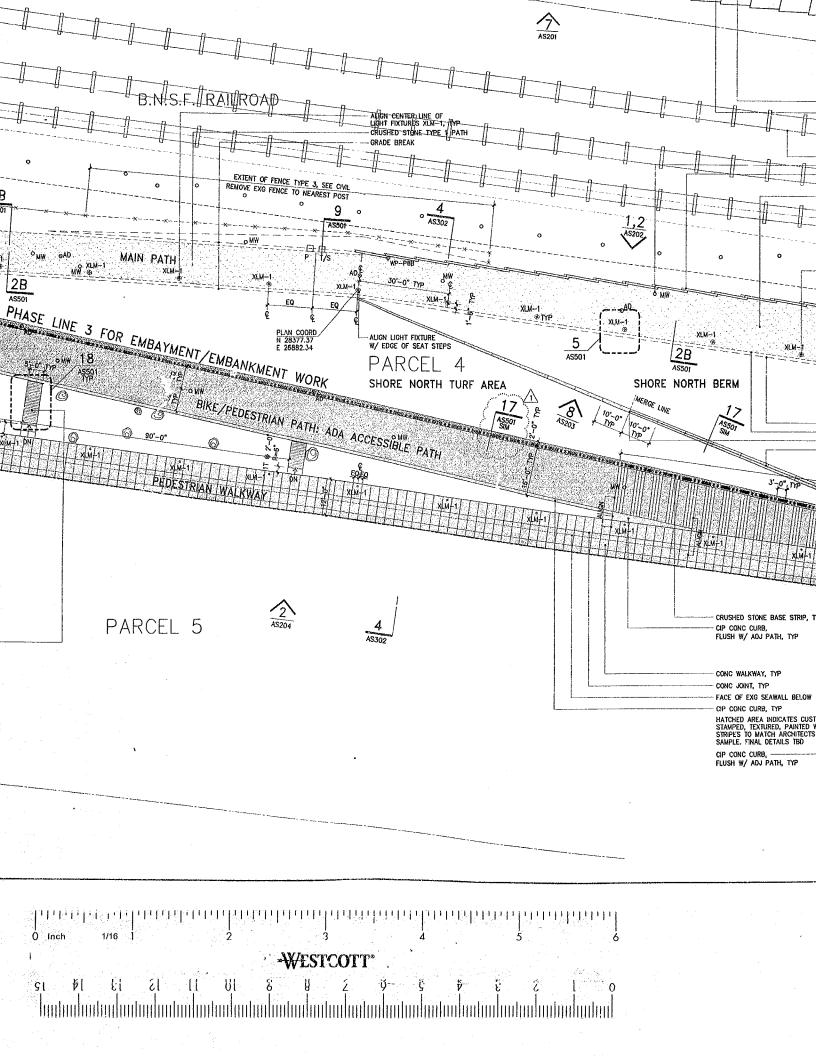
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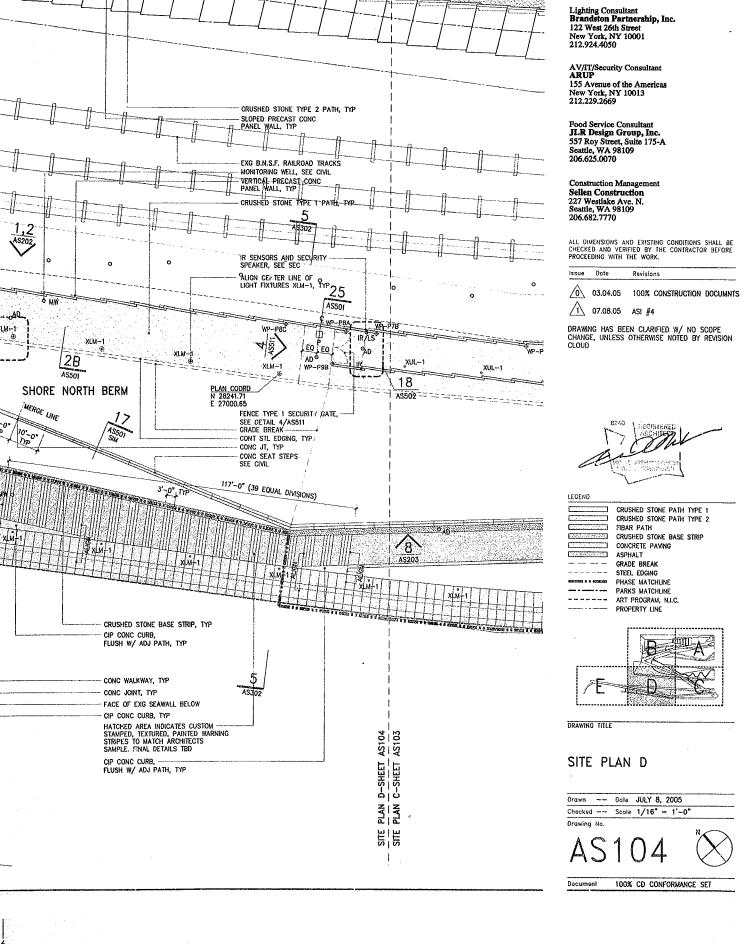
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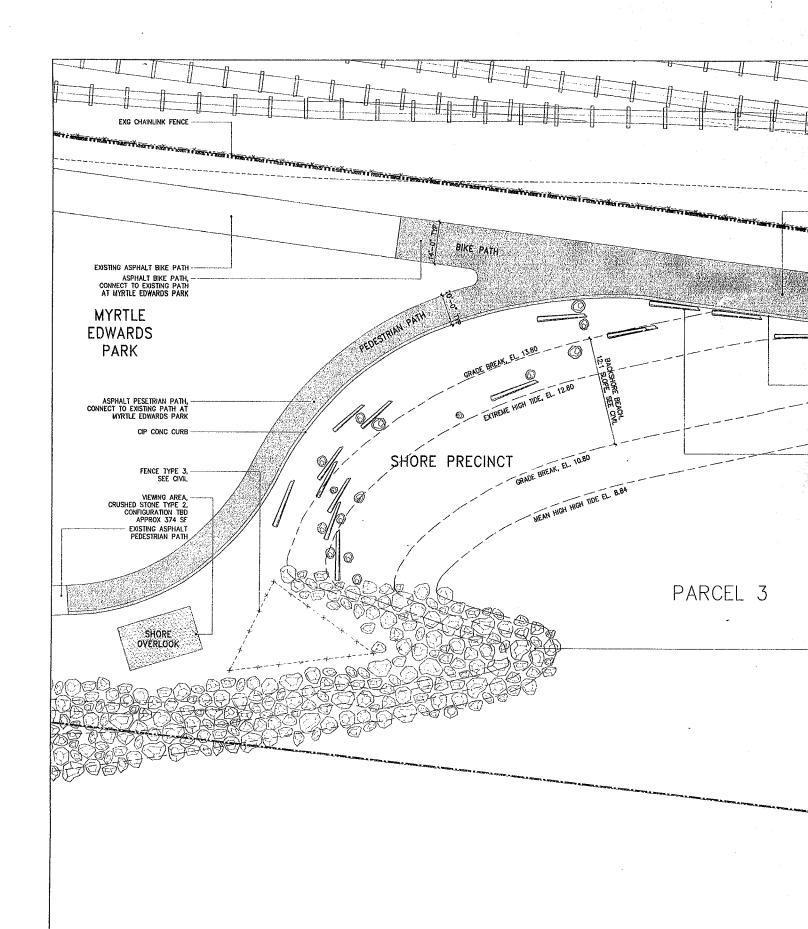



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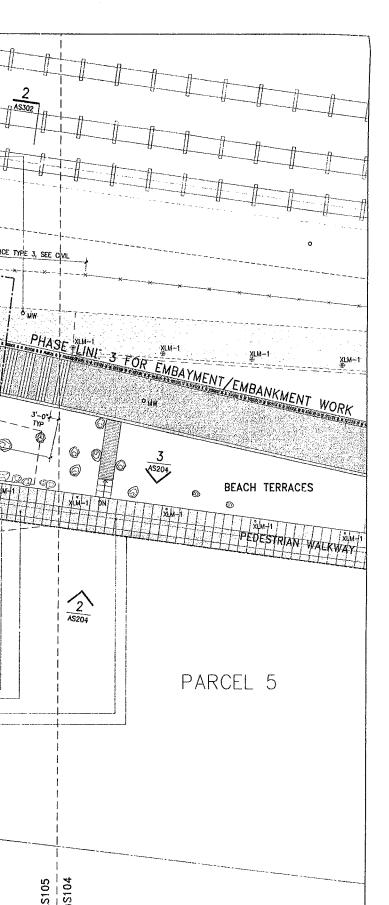
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Seattle Art Museum Seattle, Washington 100 University Street Seattle, WA 98101

LEAD DESIGNER Site Design / Architecture Weiss / Manfredi Architects 130 West 29th Street, 12th floor New York, NY 10001 212.760.9002
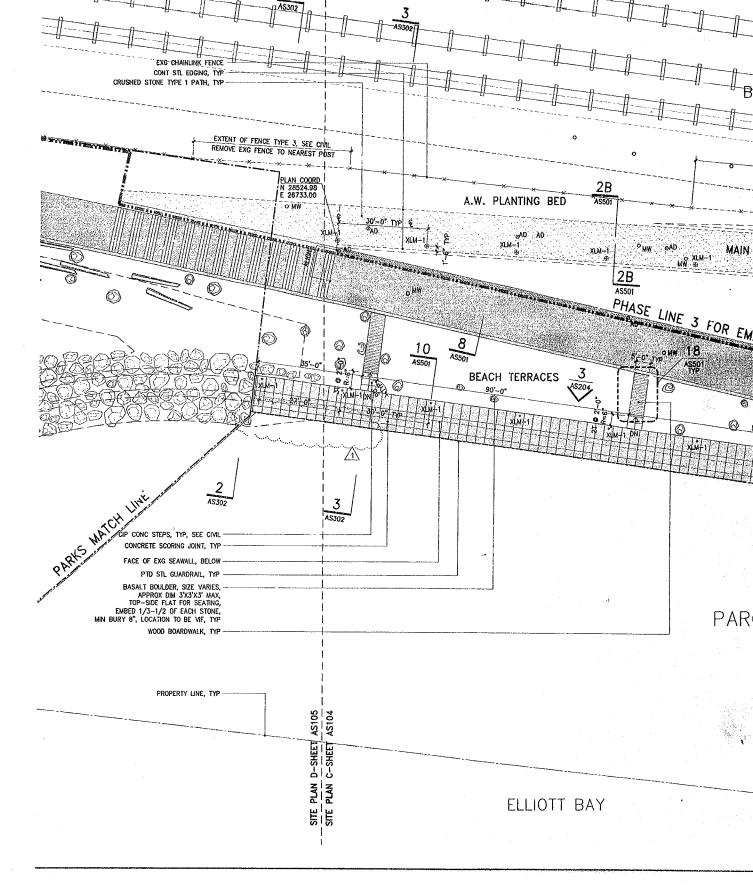
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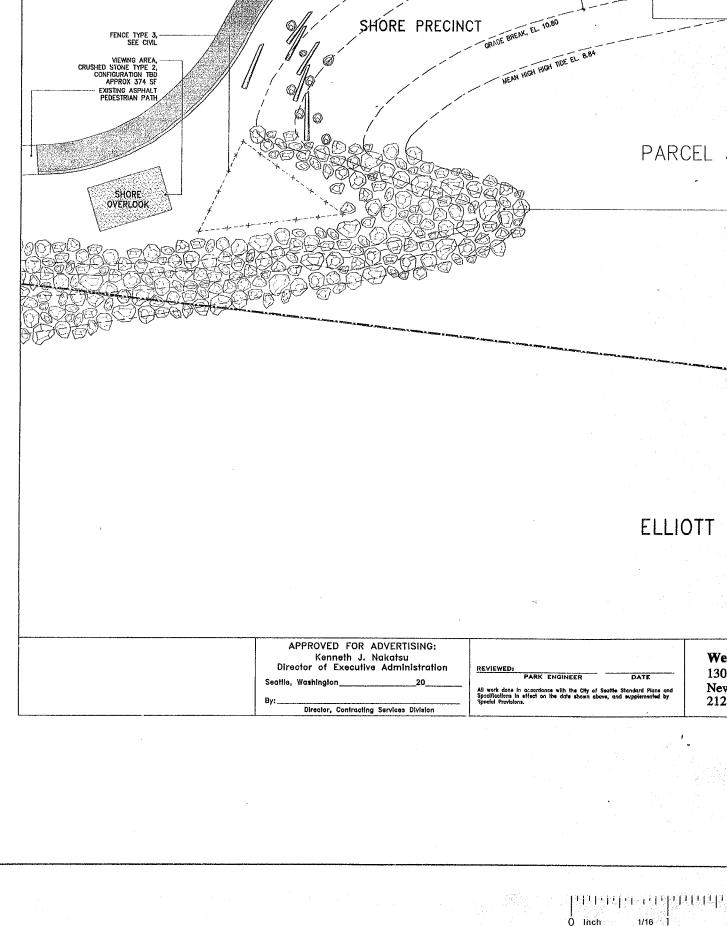
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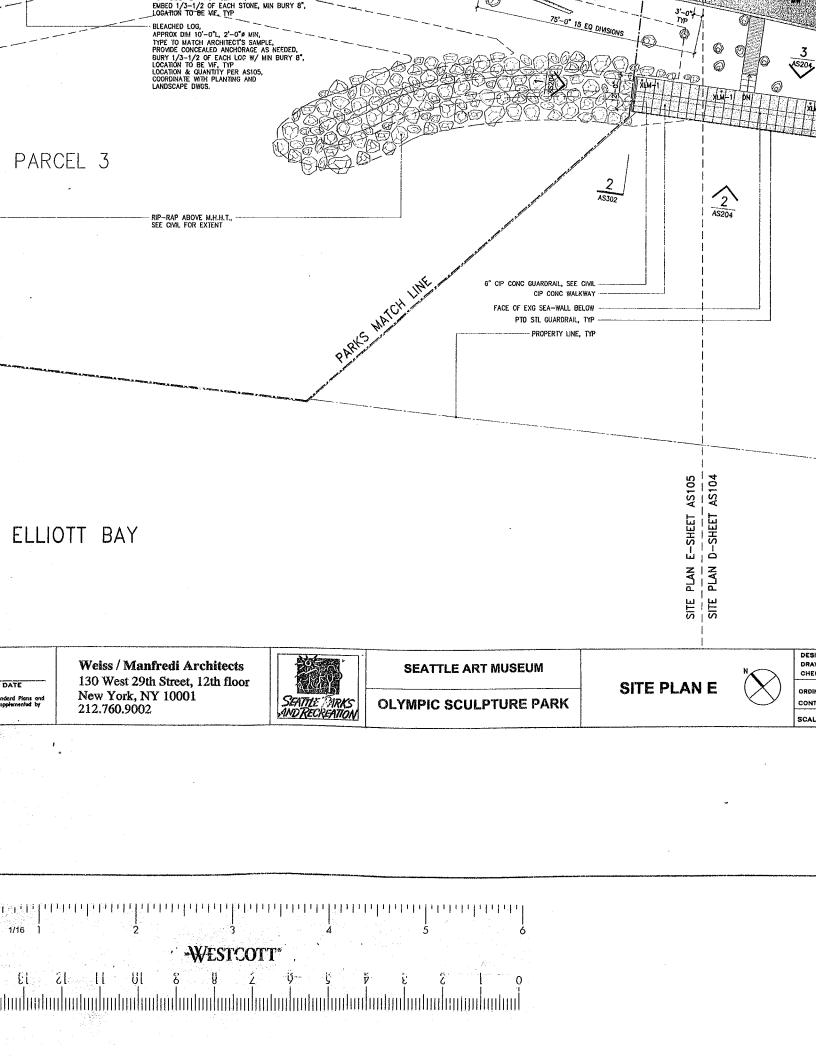
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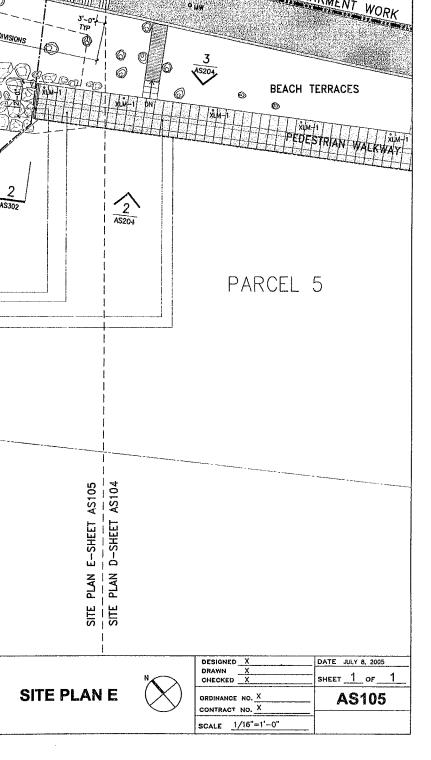


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CRUSHED STONE PATH TYPE 1



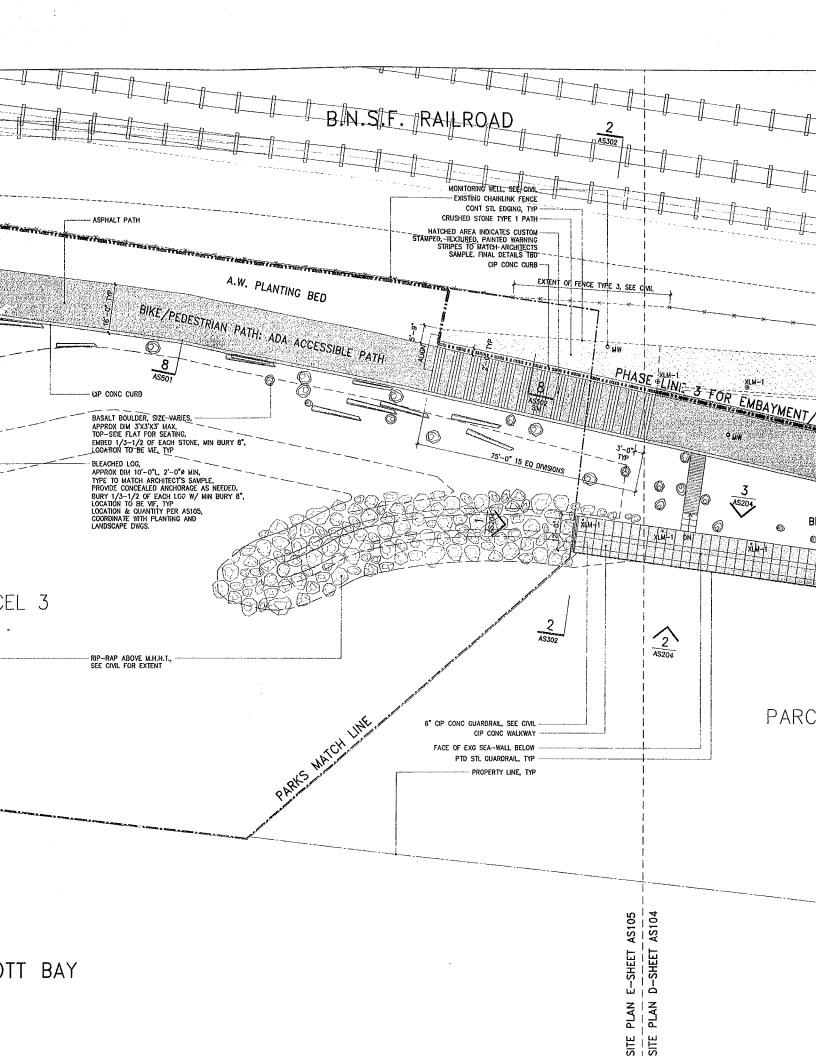



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Food Service Consultant JLR Design Group, Inc. 557 Roy Street, Suite 175-A Seattle, WA 98109 206.625.0070


Construction Management Sellen Construction 227 Westlake Ave. N. Seantle, WA 98109 206.682.7770


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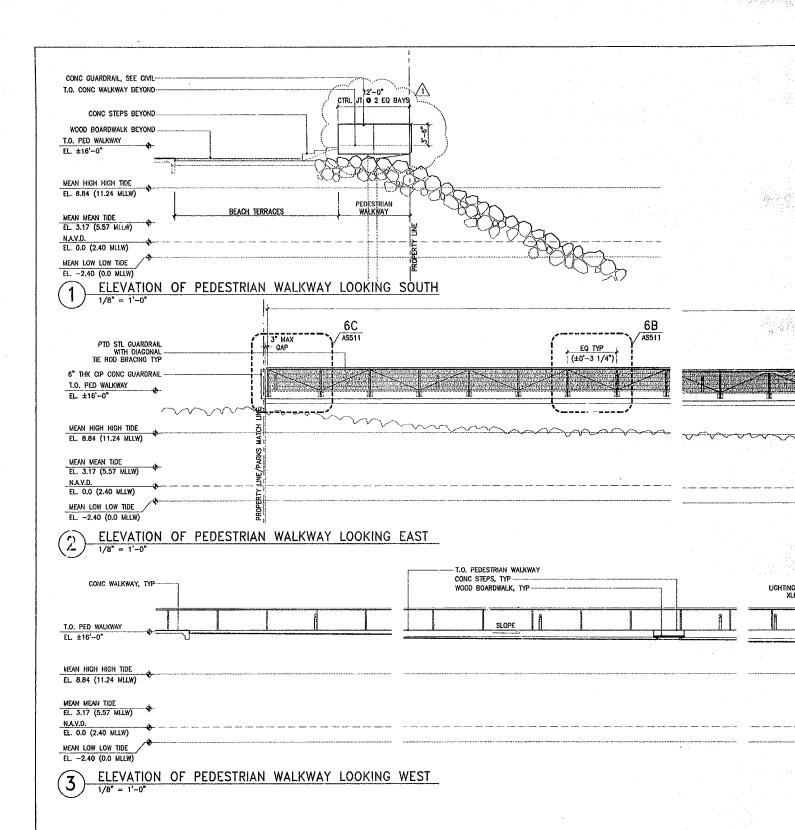
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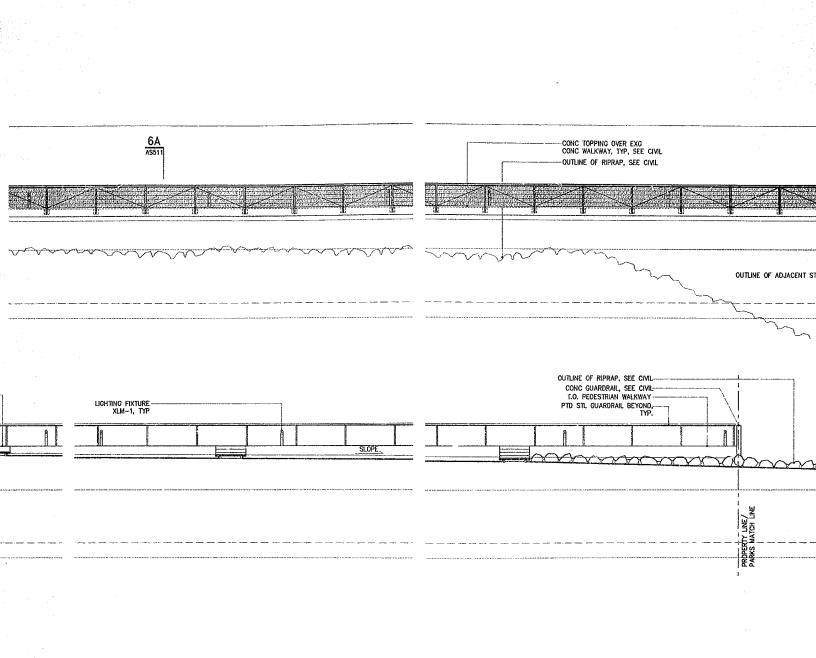
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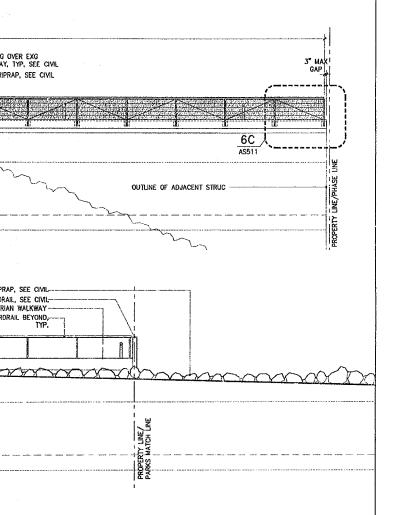
AS105



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Scattle Art Museum Scattle, Washington 100 University Street Scattle, WA 98101

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Environmental Engineering Consultant Aspect Consulting 811 First Avenue, Suite 480 Seattle, WA 98104 206.838.5840

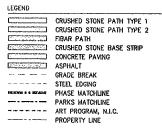Lighting Consultant Brandston Partnership, Inc. 122 West 26th Street New York, NY 10001 212.924.4050

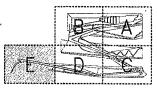
AV/IT/Security Consultant ARUP 155 Avenue of the Americas New York, NY 10013 212.229.2669


Pood Service Consultant JLR Design Group, Inc. 557 Roy Street, Suite 175-A Seattle, WA 98109 206.625.0070

Construction Management Sellen Construction 227 Westiake Ave. N. Seattle, WA 98109 206.682.7770

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SITE ELEVATIONS EMBAYMENT/EMBANKMENT

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CONTRACT NO. X	AS204
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DESIGNED X	DATE JULY 8, 2005

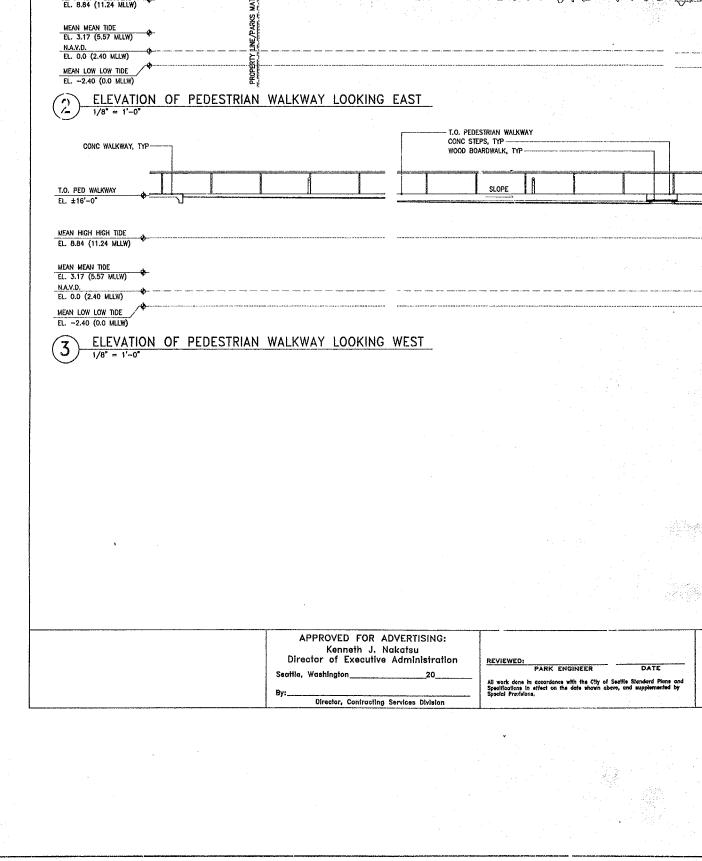Brandston Partnership, Inc. 122 West 26th Street New York, NY 10001 212.924.4050

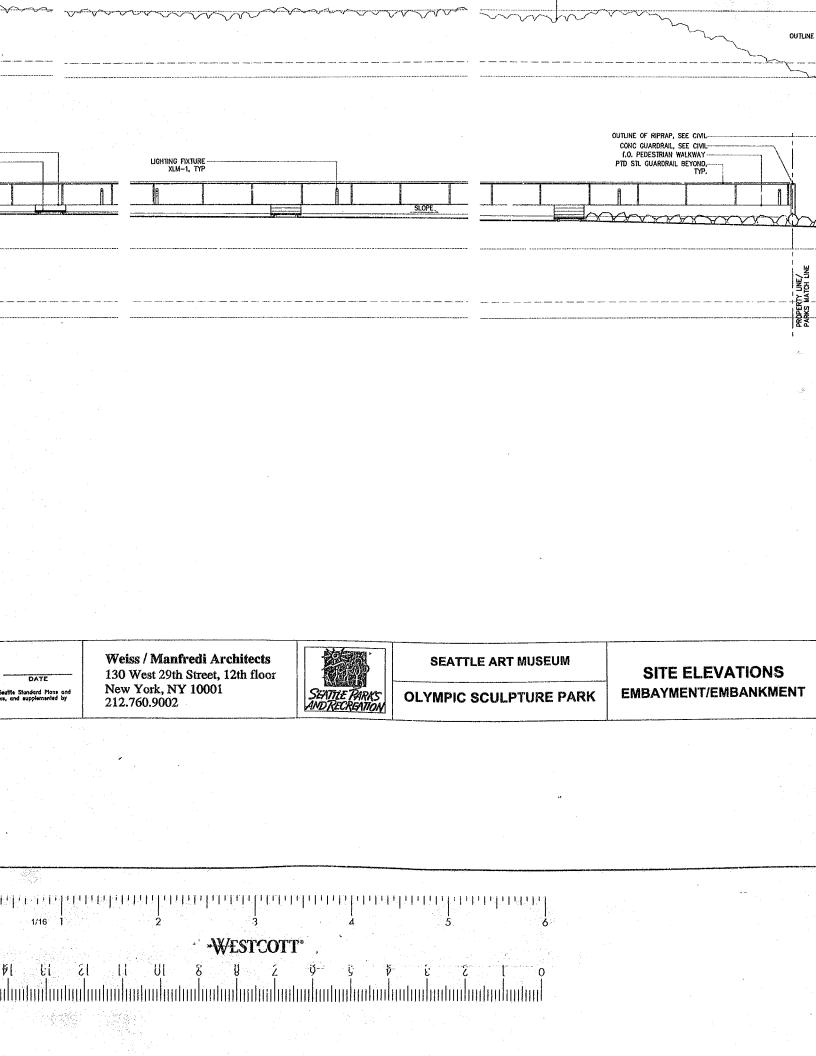AV/IT/Security Consultant ARUP 155 Avenue of the Americas New York, NY 10013 212.229.2669


Food Service Consultant JLR Design Group, Inc. 557 Roy Street, Suite 175-A Seattle, WA 98109 206.625.0070

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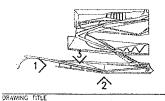
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<u></u>	03.04.05	100% CONSTRUCTION DOCUMNTS
\triangle	07.08.05	ASI #4

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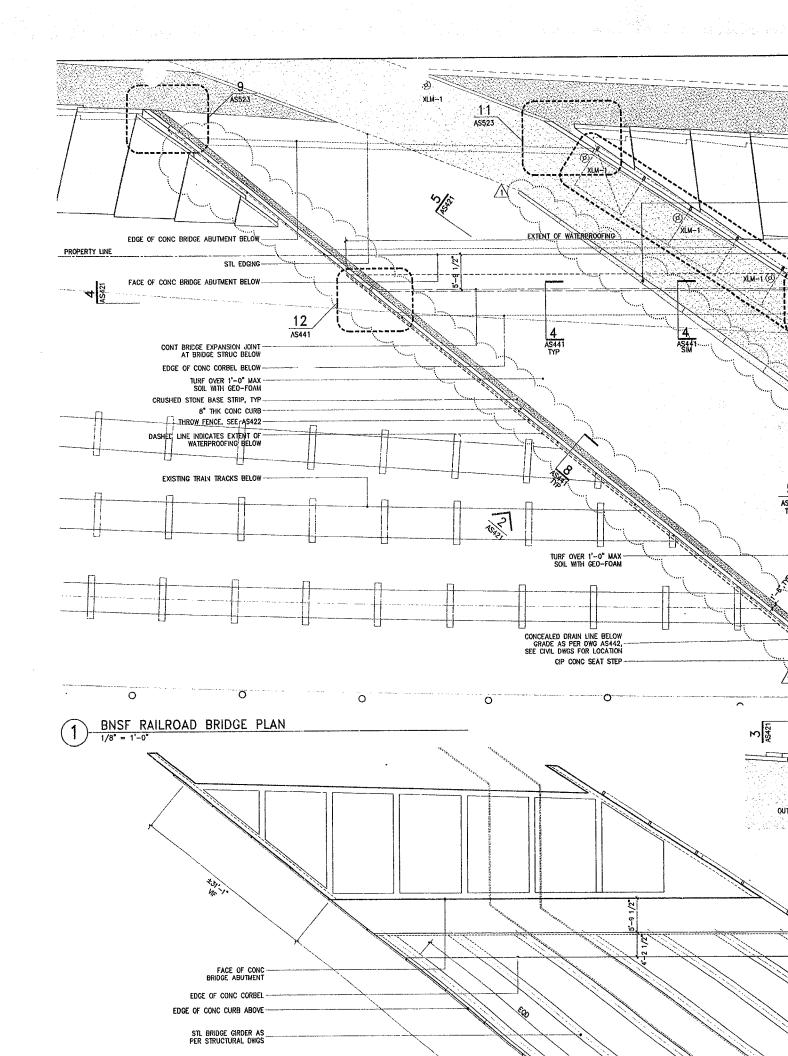



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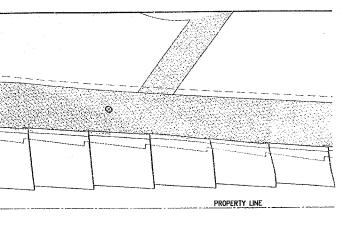
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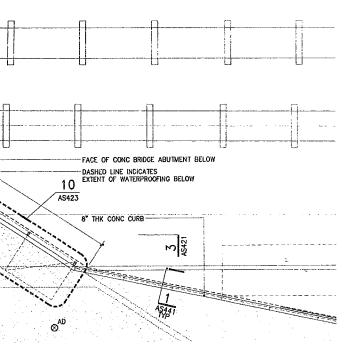
AS204

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GENERAL NOTES:

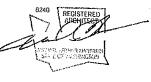1. ALL EXPOSED FRAMING, DECK CONDUIT AND FIXTURES TO BE FINISHED TO MATCH ARCHITECTS SAMPLE.

- 2. AT ELLIOTT BRIDGE ALL EXPOSED BEAM FLANGES TO BE PROVIDED WITH BIRD PROTECTION AS PER 11/AS442. ALL GAPS BETWEEN BEAMS AT GRADE BEAM TO BE PROVIDED WITH CONTINUOUS FULLY SEALED VERTICAL BIRD PROTECTION SCREEN.
- 3. SEE DRAWING AS441 FOR TYPICAL WATERPROOFING DETAILS. PROVIDE CONTINUOUS FULLY SEALED WATER PROOFING ABOVE ALL BRIDGE STRUCTURE.
- 4 SEE DWG AS442 FOR TYPICAL LIGHTING DETAILS. ALL CONDUIT TO BE TIGHT TO UNDERSIDE OF DECK. FINAL LOCATION OF ALL EXPOSED FIXTURES AND CONDUIT TO BE VERIFIED BY ARCHITECT PRIOR TO INSTALLATION.
- 5. ALL PLANTING SOIL OVER BRIDGE STRUCTURE TO BE 12" MAX. PLACE GEO-FOAM TO MATCH GRADING REQUIREMENTS.
- 6. ALL STRUCTURAL MEMBERS & METAL DECKING TO BE PRIMED / GALVANIZED & PAINTED AS PER SPECIFICATIONS.
- 7. FOR PTD STL GUARDRAIL DETAILS, SEE AS511.
- 8. SEE LANDSCAPE FOR ALL TOP SOIL & PLANTING INFO.

Olympic Sculpture Park

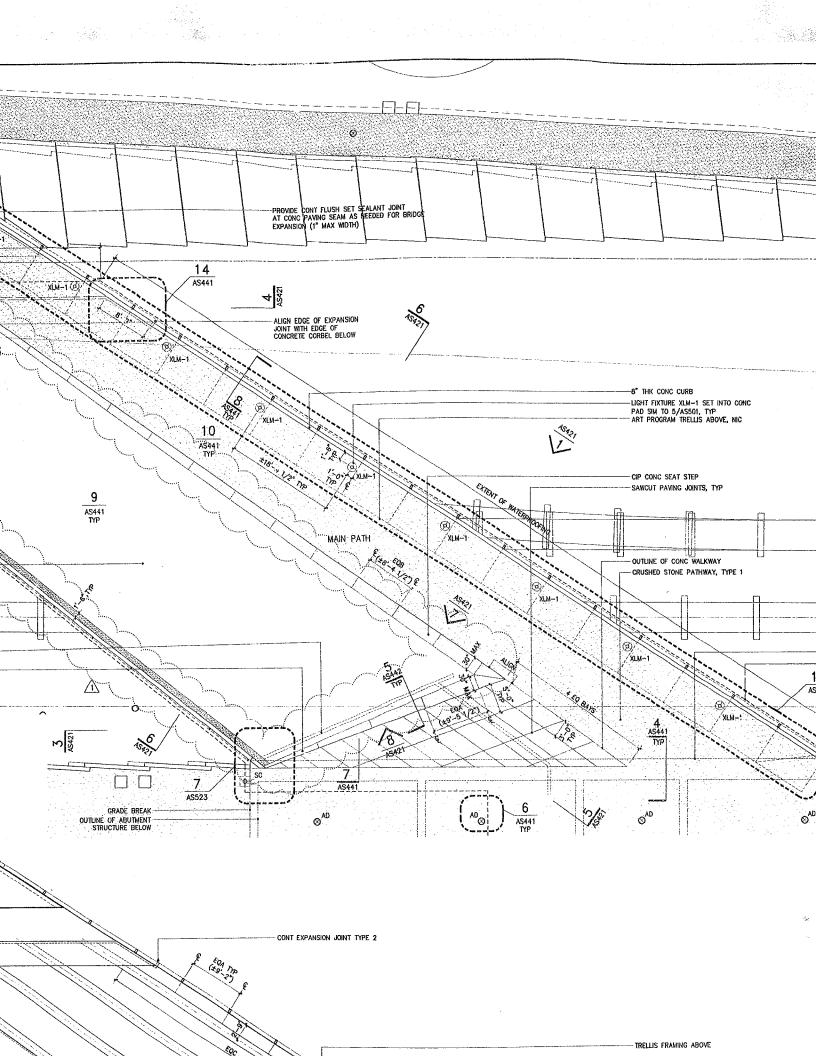Seattle Art Museum Seattle, Washington 100 University Street Seattle, WA 98101

LEAD DESIGNER Site Design / Architecture Welss / Manfredi Architects 130 West 29th Street, 12th floor New York, NY 10001 212.760.9002

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Lighting Consultant Brandston Partnership, Inc. 122 West 26th Street New York, NY 10001 212,924,4050

AV/IT/Security Consultant ARUP 155 Avenue of the Americas New York, NY 10013 212.229.2669


Food Service Consultant JLR Design Group, Inc. 557 Roy Street, Suite 175-A Seattle, WA 98109 206.625.0070

Construction Management Sellen Construction 227 Westlake Ave. N. Seattle, WA 98109 206.682.7770


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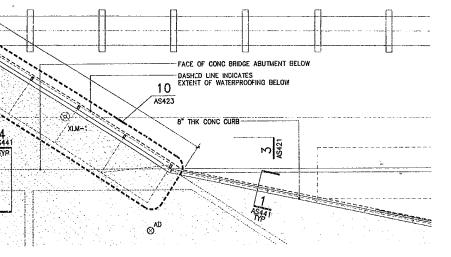
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8240 REGISTERED ARCTORES



2) BNSF RAILROAD BRIDGE RCP

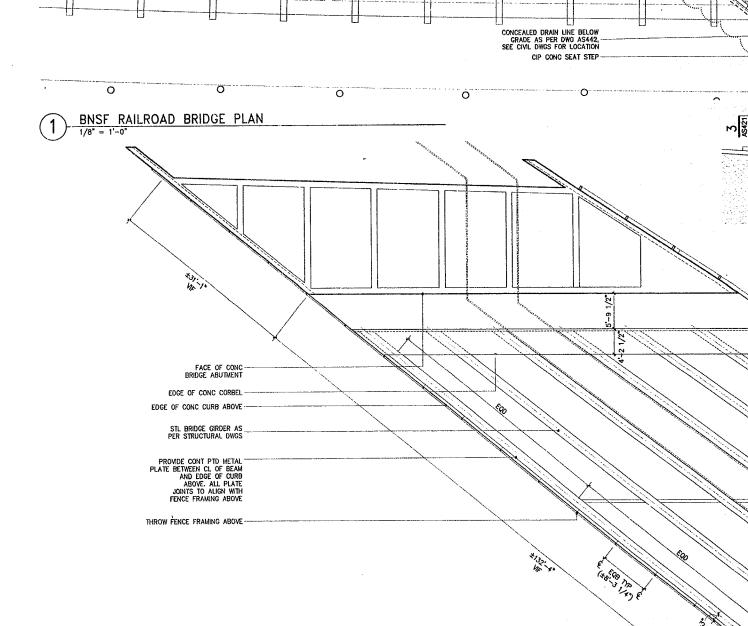

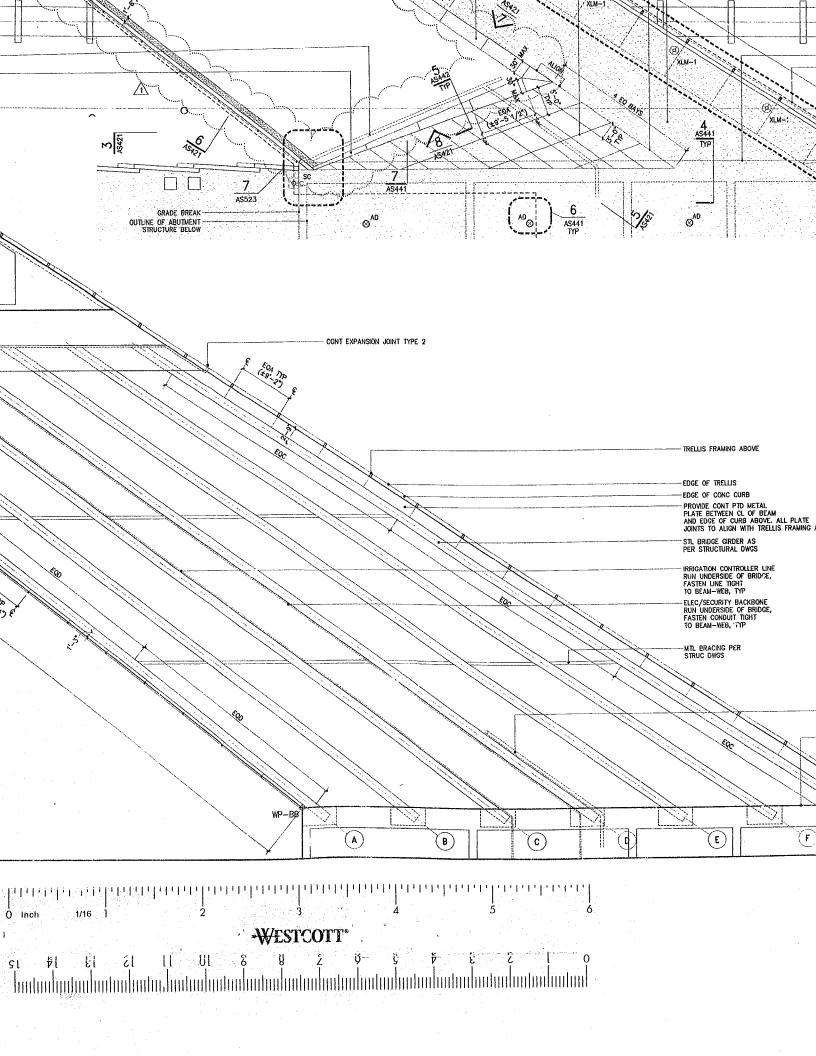

<u>GENERAL_NOTES</u>:

1. ALL EXPOSED FRAMING, DECK CONDUIT AND FIXTURES TO BE FINISHED TO MATCH ARCHITECTS SAMPLE.

2. AT ELLIOTT BRIDGE ALL EXPOSED BEAM FLANGES TO BE PROVIDED WITH BIRD PROTECTION AS PER 11/AS442. ALL GAPS BETWEEN BEAMS AT GRADE BEAM TO BE PROVIDED WITH CONTINUOUS FULLY SEALED VERTICAL BIRD PROTECTION SCREEN.

3. SEE DRAWING AS441 FOR TYPICAL WATERPROOFING DETAILS. PROVIDE CONTINUOUS FULLY SEALED WATER PROOFING ABOVE ALL BRIDGE STRUCTURE.

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6. ALL STRUCTURAL MEMBERS & METAL DECKING TO BE PRIMED / GALVANIZED & PAINTED AS PER SPECIFICATIONS.

7. FOR PTO STL GUARDRAIL DETAILS, SEE AS511.

8. SEE LANDSCAPE FOR ALL TOP SOIL & PLANTING INFO.

9. FOR ALL STREET SIDEWALK INFO, SEE CIVIL.

10. FOR ALL DIMENSIONS / REINFORCING & T.O. ELEVATION OF CIP CONCRETE, SEE CIVIL & STRUCTURAL.

11. FOR STL EDGING PATHWAY STAKES, CUT DOWN TO ALLOW 2° CLEAR OVER ALL WATERPROOFING MATERIALS ON BRIDGE STRUCTURE.

12. COORDINATE LOCATIONS OF ELEC/SEC FIXTURE INSTALLATION W/WATERPROOFING.

13. SEE DWG ASSOI FOR TYPICAL CONCRETE JOINT DETAILS. ALL EXPOSED CONCRETE JOINT TYPES AND LOCATIONS TO BE VERIFIED WITH ARCHITECT PRIOR TO INSTALLATION.

14. SEE DWG AS521-AS522 FOR TYPICAL PRECAST WALL GUARDRAIL DETAILS.

S FRAMING ABOVE

OF TRELLIS OF CONC CURB DE CONT PTD METAL
BETYMEN CL OF BEAM
DOE OF CURB ABOVE. ALL PLATE
TO ALIGN WITH TRELLIS FRAMING ABOVE

RIDGE GIRDER AS TRUCTURAL DWGS

tion controller line nderside of Bridge, n line tight am—web, typ

SECURITY BACKBONE NDERSIDE OF BRIDGE N CONDUIT TIGHT AM-WEB, TYP

RACING PER

DRAIN LINE CONNECTION FROM ABOVE SLAB AS PER DWG AS442, RUN UNDERSIDE OF BRIDGE, FASTEN CONDUIT TIGHT TO BEAM-WEB, TYP, SEE CIVIL DWGS FOR LOCATION FACE OF CONC BRIDGE ABUTMENT WP-BB E (F)G

New York, NY 10001 212,924.4050

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New York, NY 10013
212.229.2669

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Date

Revisions

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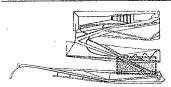
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	CRUSHED STONE PATH TYPE
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	STEEL EDGING
127,80M & 6 EXPRISE	PHASE MATCHLINE
	PARKS MATCHLINE
	ART PROGRAM, N.I.C.
	PROPERTY LINE

KEY



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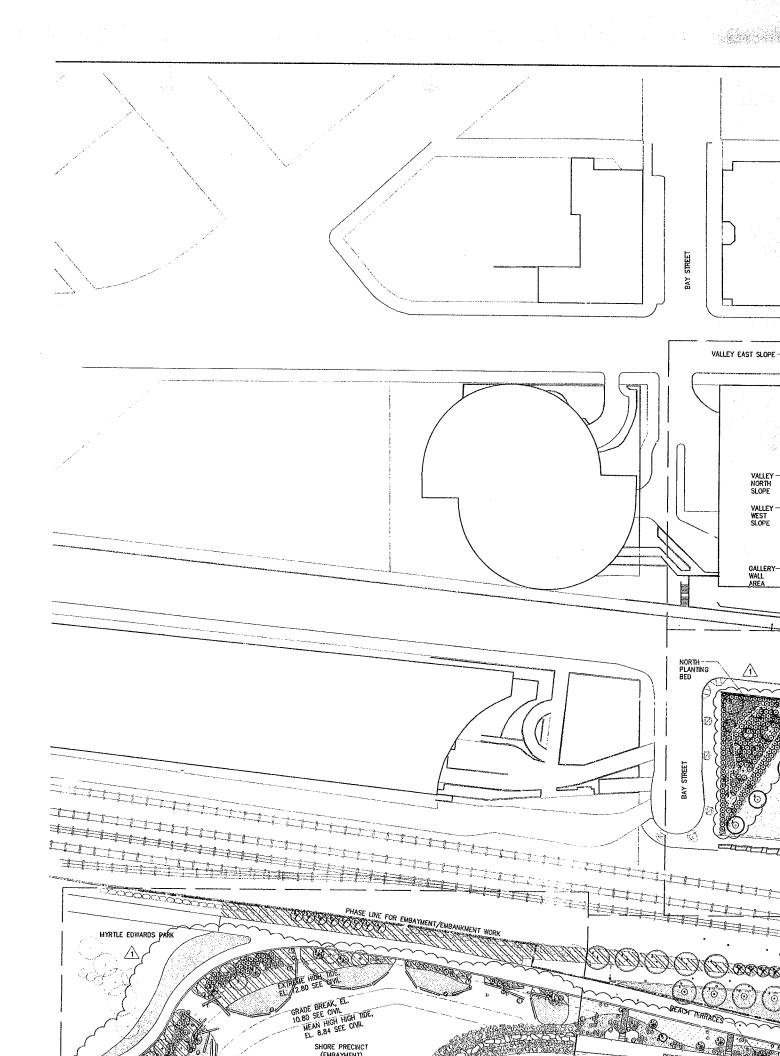
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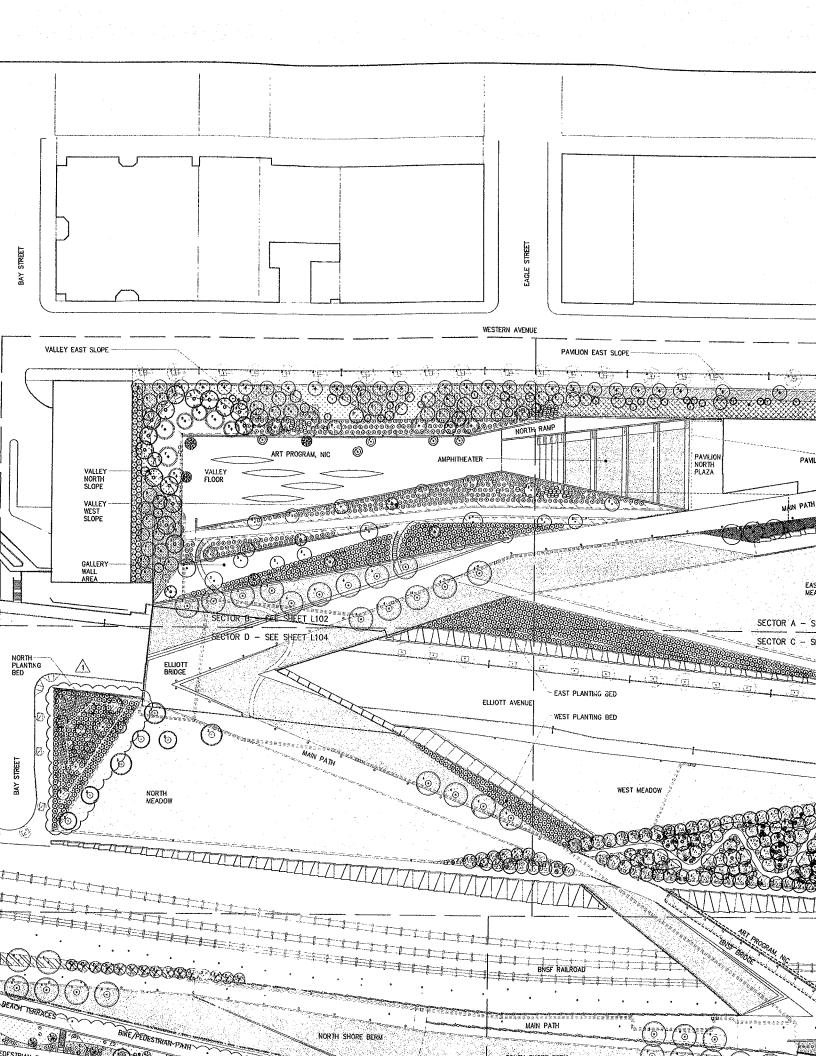
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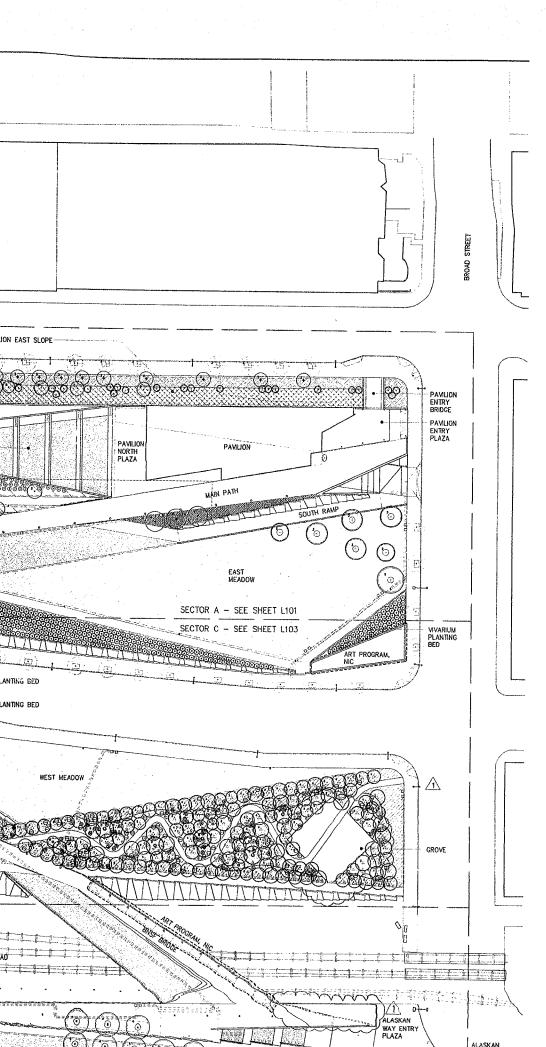
AS420



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Seattle Art Museum Seattle, Washington 100 University Street Seattle, WA 98101

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Weiss / Manfredi Architects
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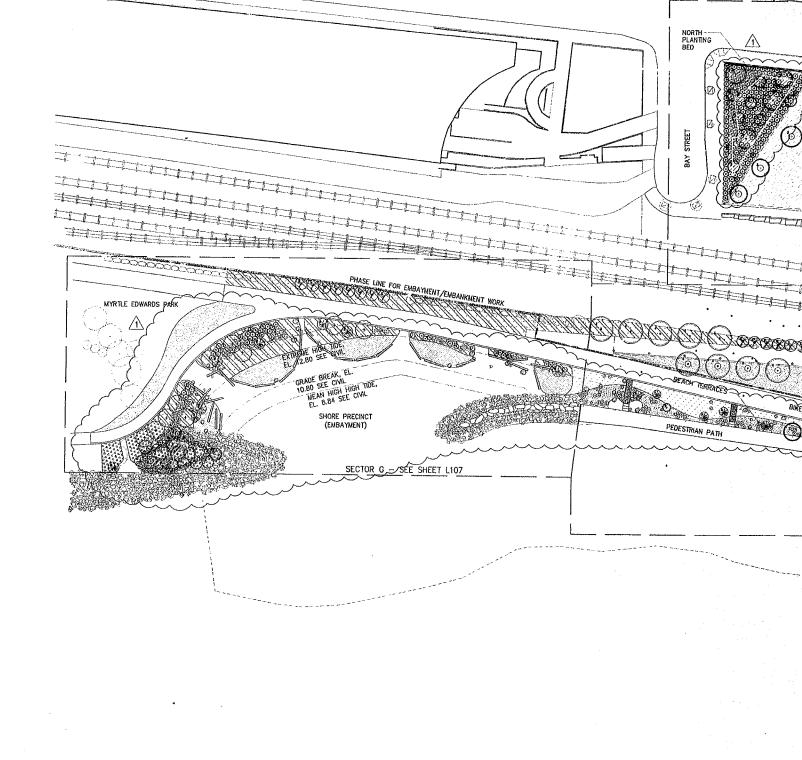
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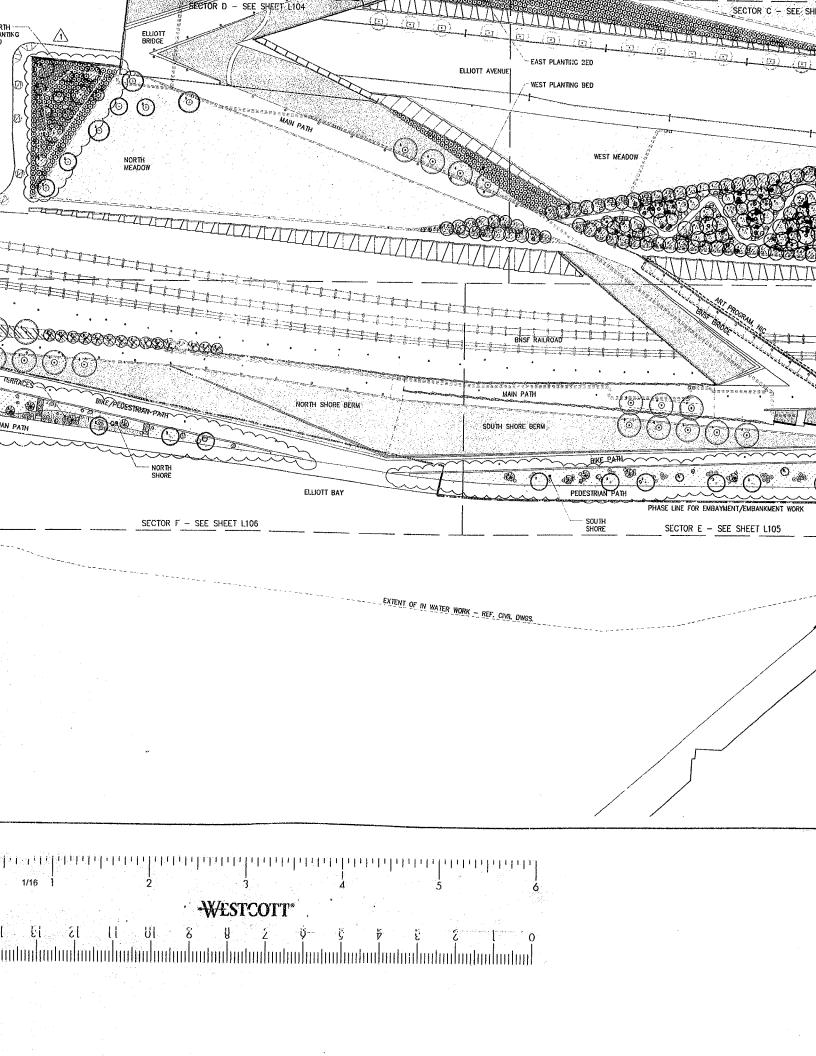
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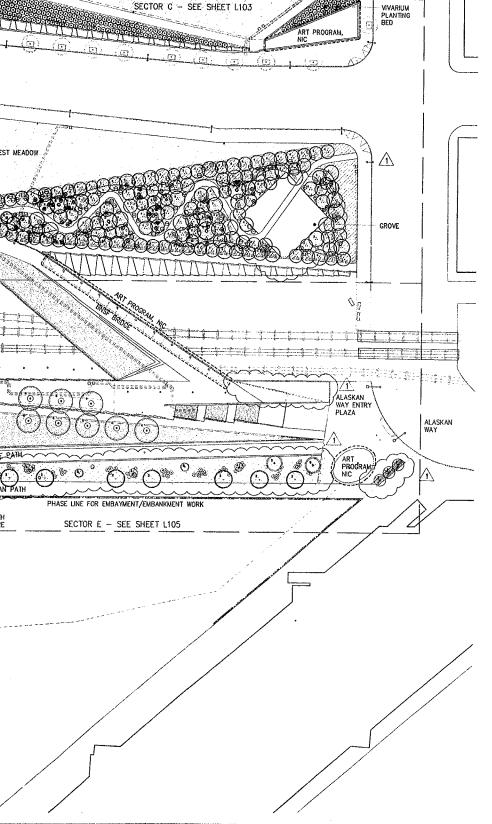
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DRAWING TITLE

PLANTING PLAN KEY PLAN

Orawn SM/JP Date JULY 8, 2005 Checked CA Scale 1" = 40'

Drawing No.




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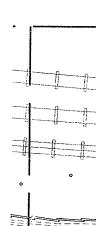
TREES					
SYMBOL	BOTANICAL NAME	COMMON NAME	SIZE	SPACING	COMMENTS
	PICEA SITCHENSIS	SITKA SPRUCE	6-8' HT.	AS SHOWN	
not Shown	ARBUTUS MENZIESII	MADRONE	1 GAL.	FIELD LOCATE	
	PINUS CONTORTA CONTORTA	SHORE PINE	4-6' HT.	AS SHOWN	
2 -	QUERCUS GARRYANA	GARRY OAK	2" CAL.	AS SHOWN	
The state of the s	THUJA PLICATA	WESTERN RED CEDAR	10-12' HT.	AS SHOWN	
(1.)	ULMUS 'ACCODLADE'	ACCOLADE ELM	4" CAL.	AS SHOWN	
SHRUBS					
SYMBOL	BOTANICAL NAME	COMMON NAME	SIZE	SPACING	COMMENTS
⊗	ARCTOSTAPHYLOS COLUMBIANA	HAIRY MANZANITA	5 GAL.	AS SHOWN	
PLANT MIXES					
SYMBOL	BOTANICAL NAME	COMMON NAME	SIZE	SPACING	COMMENTS
	DESCAMPSIA CAESPITOSA	TUFTED HAIRGRASS	PLUG	36" O.C.	
<u> </u>	ELYMUS GLAUCUS	BLUE WLD RYE	PLUG	24" O.C.	
	FRAGARIA CHILOENSIS	BEACH STRAWBERRY	4" POTS	24" O.C.	
	FESTUCA IDAHOENSIS	IDAHO FESCUE	PLUG	48" O.C.	
	FRAGARIA CHILOENSIS	BEACH STRAWBERRY	4" POTS	ε` ο.c.	
TURF					
SYMBOL	COMMON NAME				COMMENTS
	SOD TURF GRASS				

PLANTING NOTE


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- 2. CONTRACTOR IS REQUIRED TO VERIFY UTILITY LOCATIONS PRIOR TO CONSTRUCTION. CONTRACTOR SHALL CALL THE UTILITIES UNDERGROUND LOCATION CENTER (800-424-5555) AT LEAST TWO DAYS PRIOR TO CONSTRUCTION.
- 3. PLANT MATERIALS SHALL MEET STANDARDS SET FORTH IN THE LATEST EDITION OF THE AMERICAN STANDARD FOR NURSERY STOCK (ANSI-Z80.1) AND WASHINGTON STATE STANDARDS FOR NURSERY STOCK, ORDER NO. 1627. ALL PLANT MATERIAL SHALL HAVE SUFFICIENT ROOT DEVELOPMENT TO ASSURE SURVIVAL AND HEALTHY GROWN CONTAINER GROWN PLANT MATERIALS ARE REQUIRED TO HAVE SUFFICIENT ROOT GROWTH TO HOLD THE SOIL INTACT WHEN REMOVED FROM THE CONTAINER, BUT SHALL NOT BE ROOT BOUND.
- 4. ALL TREES SHALL HAVE HEALTHY AND STRONG CENTRAL LEADERS TO ENSURE OPTIMUM GROWTH AND SURVIVAL.
- 5. ALIGN ROWS OF TREES, SHRUBS AND GROUNDCOVER TO ADJACENT WALLS, $\,$ PATHS, AND GRADE BREAKS UNLESS OTHERWISE NOTED.
- 6. ALL DIMENSIONS ARE TO CENTER OF TREE UNLESS OTHERWISE NOTED.






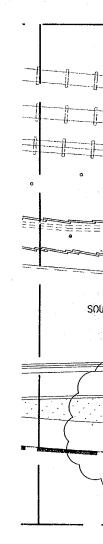


SOU

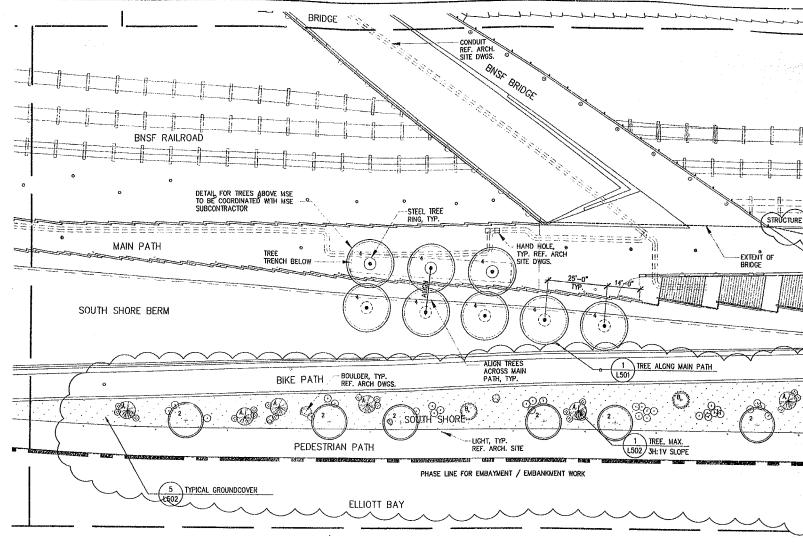

SECTOR F TREE AND GROUNDCOVER PLANTING PLAN

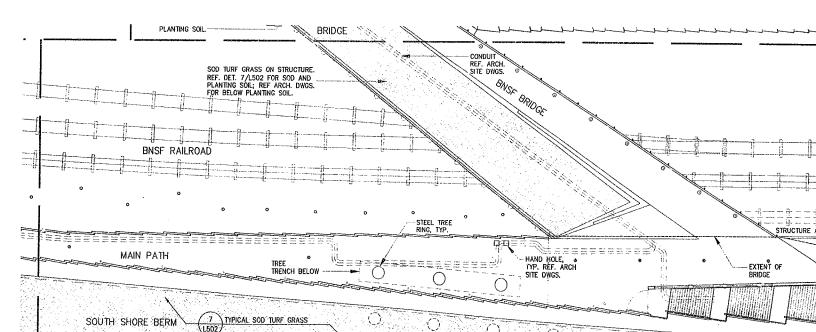

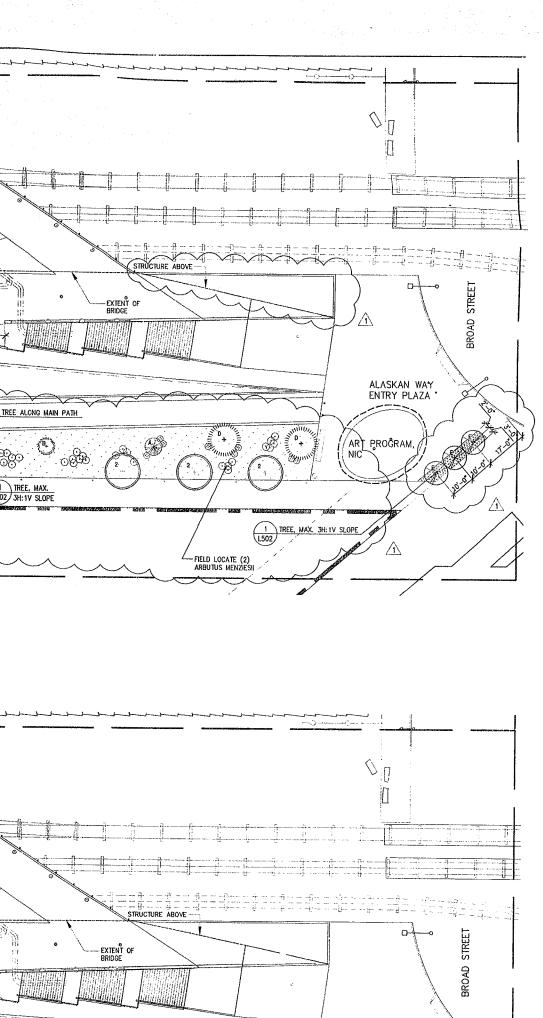

Seattle Art Museum Seattle, Washington 100 University Street Seattle, WA 98101

LEAD DESIGNER Site Design / Architecture
Welss / Manfredl Architects
130 West 29th Street, 12th floor
New York, NY 10001
212.760.9002

CONSULTANT TEAM
Structural & Civil Engineering Consultant
Magnusson Klemencic Associates 1301 Fifth Avenue, Suite 3200 Seattle, WA 98101 206.292.1200

Landscape Architecture Consultant Charles Anderson Landscape Architecture 83 Columbia Street, Suite 301 Seattle, WA 98104 206.516.4200

MEPFP Engineering Consultant ABACUS Engineered Systems 401 Second Avenue South, Suite 201 Seattle, WA 98104 206.583.0200

Aquatic Science Engineering Consultant Anchor Environmental 1423 3rd Avenue, Suite 300 Seatele, WA 98101 265.387.9130

Geotechnical Engineering Consultant Hart-Crowser, Inc. 1910 Fairview Avenue East Seattle, WA 98102 206.324.9530

Environmental Engineering Consultant Aspect Consulting 811 First Avenue, Suite 480 Seattle, WA 98104 206.838.5840

Lighting Consultant Brandston Partnership, Inc. 122 West 26th Street New York, NY 10001 212,924,4050

AV/IT/Security Consultant ARUP 155 Avenue of the Americas New York, NY 10013 212.229.2669

Food Service Consultant JLR Design Group, Inc. 557 Roy Street, Suite 175-A Seattle, WA 98109 206.625.0070

Construction Management Sellen Construction 227 Westlake Ave. N. Seattle, WA 93109 206.682.7770

ALL DIMENSIONS AND EXISTING CONDITIONS SHALL BE CHECKED AND VERIFIED BY THE CONTRACTOR BEFORE PROCEEDING WITH THE WORK.

Date Revisions

03.04.05 100% CONSTRUCTION DOCUMENTS


1 07.08.05 AS! #4

DRAWING HAS BEEN CLARIFIED W/ NO SCOPE CHANGE, UNLESS OTHERWISE NOTED BY REVISION CLOUD


SOD TURF GRASS

PLANTING NOTES:


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- 4. ALL TREES SHALL HAVE HEALTHY AND STRONG CENTRAL LEADERS TO ENSURE OPTIMUM GROWTH AND SURVIVAL
- 5. ALIGN ROWS OF TREES, SHRUBS AND GROUNDCOVER TO ADJACENT WALLS, PATHS, AND GRADE BREAKS UNLESS OTHERWISE NOTED.
- 6. ALL DIMENSIONS ARE TO CENTER OF TREE UNLESS OTHERWISE NOTED.
- 7. REFER TO TYPICAL PLANTING DETAILS FOR SHRUBS, GROUNDCOVER, SOD TURF GRASS, MEADOW GRASS AND PLUGS ON SHEET L502 UNLESS OTHERMISE NOTED.
- 8. REFER TO SHEET L301 FOR MASTER PLANT SCHEDULE AND FIELD LOCATED PLANTS.
- 9. REFER TO SHEET L401 FOR TYPE AND DEPTH OF PLANTING SOIL MIXES.
- 10. MULCH SHALL BE INSTALLED TO A DEPTH OF 3-INCHES IN ALL PLANTING BEDS EXCEPT INSTALL NO MULCH AT SHORE PRECINCT BEACH.
- 11. INSTALL TEMPORARY PROTECTION BARRIER ALONG PERIMETER OF ALL MEADOW AREAS TO PREVENT ACCESS AND DISTURBANCE TO MEADOW AREAS. BARRIER SHALL REMAIN IN PLACE UNTIL GRASS IS WELL ESTABLISHED AND EXHIBITS A VICOROUS GROWING CONDITION AS APPROVED BY LANDSCAPE ARCHITECT. REFER TO SECTION 02930.
- 12. INSTALL TEMPORARY PROTECTION BARRIER ALONG PERIMETER OF ALL PLANTING AREAS AT SHORE PRECINCT AS SHOWN TO PREVENT ACCESS AND DISTURBANCE TO PLANTING AREAS. BARRIER SHALL REMAIN IN PLACE UNTIL PLANTS ARE WELL ESTABLISHED OR UNTIL REMOVAL IS APPROVED BY OWNER. REFER TO SECTION 02930 2.6 & 3.8.
- 13. INSTALL ROOT BARRIER ALONG PERIMETER OF GROVE AREAS AS SHOWN. SET ROOT BARRIER 2-INCHES BELOW FINISH GRADE. ROOT BARRIERS SET PRIOR TO CONSTRUCTION MAY REQUIRE ADJUSTMENT LATER TO ENSURE FINAL LOCATION IS 2-INCHES BELOW FINISH GRADE. REFER TO SECTION 02950.
- 14. REFER TO CIVIL DWGS. FOR LAYOUT, QUANTITIES, SPECIES AND PLANTING DETAIL FOR STREET TREES.
- 15. REFER TO CIVIL/ARCH. SITE DWGS. FOR LAYOUT OF SITE WALLS & HARDSCAPE ELEMENTS AND FOR GRADING.
- 16. REFER TO CIVIL FOR LIMITS OF TREE PROTECTION. REFER TO SHT. L502 FOR TREE PROTECTION DETAIL.
- 17. NO PESTICIDES, HERBICIDES OR CHEMICAL FERTILIZERS SHOULD BE APPLIED TO VEGETATION AT THE SHORE PRECINCT.

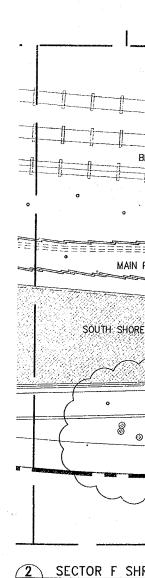

2 SECTOR F SFI

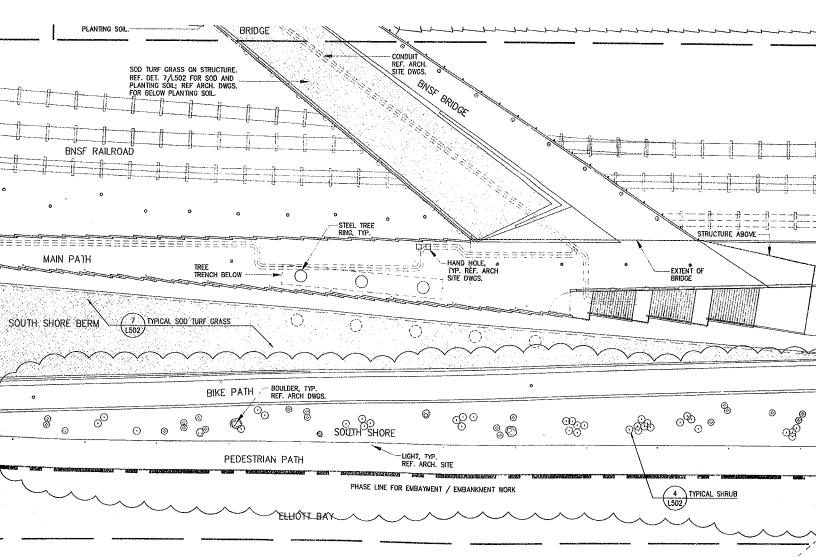

CTOR F SHRUB, TURF AND MEADOW PLANTING PLAN

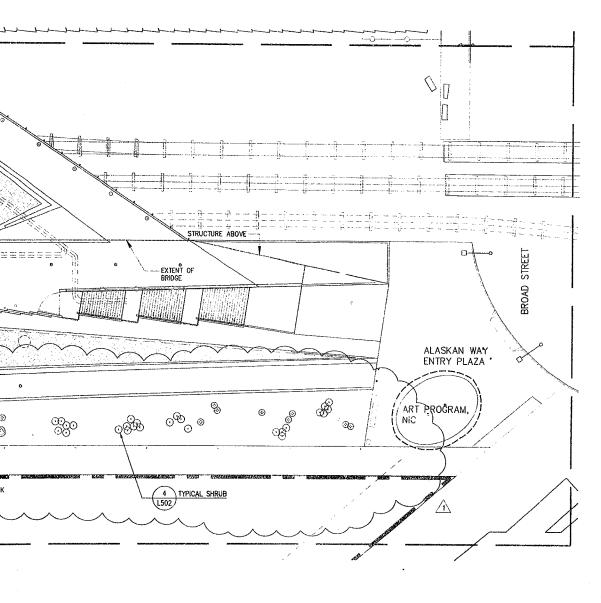

dakil.

122 West 26th Street New York, NY 10001 212.924.4050


AV/IT/Security Consultant ARUP 155 Avenue of the Americas New York, NY 10013 212.229,2669

Food Service Consultant JLR Design Group, Inc. 557 Roy Street, Suite 175-A Seattle, WA 98109 206.625.0070

Construction Management Sellen Construction 227 Westlake Ave. N. Seattle, WA 93109 206.682.7770

ALL CIMENSIONS AND EXISTING CONDITIONS SHALL BE CHECKED AND VERIFIED BY THE CONTRACTOR BEFORE PROCEEDING WITH THE WORK.

issue	Oate	Revisions	

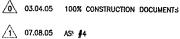

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DRAWING TITLE

PLANTING PLAN SECTOR E

Drawn SM/JP Date JULY 8, 2005 Checked CA Scale 1" = 20'

Drawing No.

105





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SYMBOL	BOTANICAL NAME	COMMON NAME	SIZE	SPACING
(F)	CALOCEDRUS DECURRENS	INCENSE CEDAR	12' 14' HT.	AS SHOW
B.	PICEA SITCHENSIS	SITKA SPRUCE	68' нт.	*⊋ SHO¥
	PINUS CONTORTA	SHORE PINE	4-6' HT.	AS SHOW
	ULMUS 'ACCODLADE'	ACCOLADE ELM	4" CAL.	AS SHOW
	QUERCUS GARRYANA	GARRY OAK	2" CAL.	AS SHOW
not Shown	SALIX SCOULERIANA	SCOULER WILLOW	15 GAL.	FIELD LOCAT
NOT SHOWN	SALIX HOOKERIANA	HOOKER'S WILLOW	15 GAL.	FIELD LOCAT
RUBS SYMBOL	BOTANICAL NAME	COMMON NAME		
		COMMON NAME	SIZE	SPACING
(S)	ARCTOSTAPHYLOS COLUMBIANA	HAIRY MANZANITA	5 GAL.	AS SHOW
O	VACCINIUM GVATUM	EVERGREEN HUCKLEBERRY	2 GAL.	AS SHOWN
NT MIXES				
SYMBOL	BOTANICAL NAME	COMMON NAME	SIZE	SPACING
	FRAGARIA CHILOENSIS	BEACH STRAWBERRY	4" POT	24" O.C.
	GAULTHERIA SHALLON	SALAL	1 GAL.	36" O.C.
	DESCAMPSIA CAESPITOSA	TUFTED HAIRGRASS	PLUG	36" O.C.
	ELYMUS GLAUCUS	BLUE WILD RYE	PLUG	24" O.C.
	FESTUCA IDAHOENSIS	IDAHO FESCUE	PLUG	48" O.C.
	FRAGARIA CHILOENSIS	BEACH STRAWBERRY	4" POT	24" O.C.
SALES	FRAGARIA CHILOENSIS	BEACH STRAWBERRY	4" POT	24" O.C.
	GAULTHERIA SHALLON	SALAL	1 GAL.	36" O.C.
	SPIREA DOUGLASII	DOUGLAS SPIREA	1 GAL.	FIELD LOCATE
•				
SYMBOL	COMMON NAME			

PLANTING NOTES:

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BINSF RAILROAD

BINSF RAILROAD

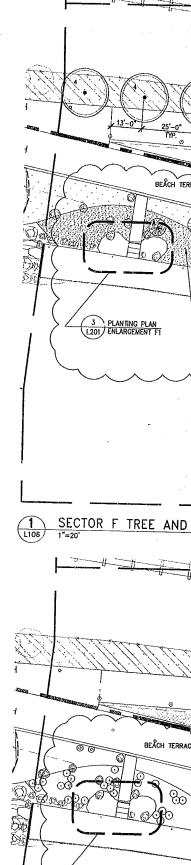MAIN PATH

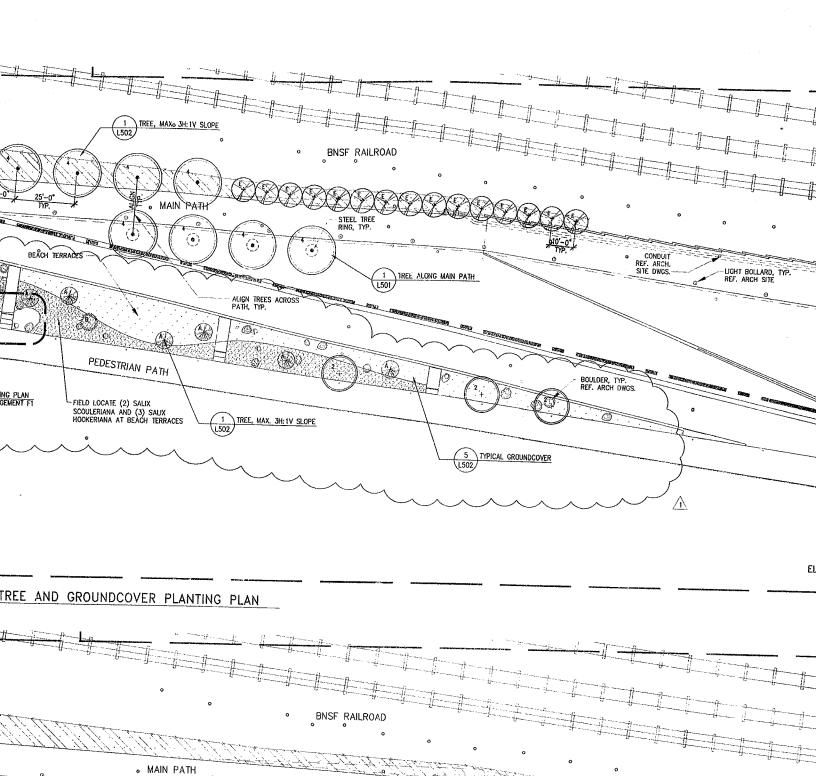COUNTY

STE DINCS.

LOT BOLLARD, TIP

REF. ARCH.

TYPICAL SOD TUR


LOT BOLLARD, TIP

REF. ARCH.

TYPICAL SOD TUR

REF. ARCH.

REF.

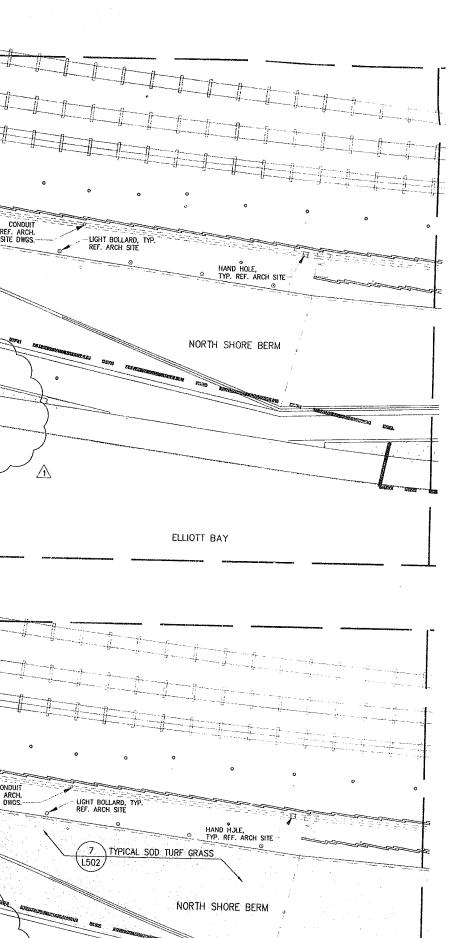

Seattle Art Museum Seattle, Washington 100 University Street Seattle, WA 98101

LEAD DESIGNER Site Design / Architecture
Weiss / Manfredi Architects
130 West 29th Street, 12th floor New York, NY 10001 212.760.9002

CONSULTANT TEAM
Structural & Civil Engineering Consultant
Magnusson Klemencic Associates
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Issue Date Revisions 0 03.04.05 100% CONSTRUCTION DOCUMENTS


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				OFACING
	FRAGARIA CHILOENSIS	BEACH STRAWBERRY	4" POT	24" 0 0
	GAULTHERIA SHALLON	SALAL	1 GAL.	24" O.C. 36" O.C.
	DESCAMPSIA CAESPITOSA	TUFTED HAIRGRASS		_
 	ELYMUS GLAUCUS	BLUE WILD RYE	PLUG PLUG	36" O.C. 24" O.C.
	FESTUCA IDAHOENSIS	IDAHO FESCUE	PLUG	48" O.C.
	FRAGARIA CHILOENSIS	BEACH STRAWBERRY	4" POT	24" O.C.
	FRAGARIA CHILOENSIS	BEACH STRAWBERRY	4" POT	24" O.C.
	GAULTHERIA SHALLON	SALAL	1 GAL.	36" O.C.
	SPIREA DOUGLASII	DOUGLAS SPIREA	1 GAL.	FIELD LOCATE
URF				
SYMBOL.	COMMON NAME			
	SOD TURF GRASS			


PLANTING NOTES:


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- 13. INSTALL ROOT BARRIER ALONG PERIMETER OF GROVE AREAS AS SHOWN. SET ROOT BARRIER 2-INCHES BELOW FINISH GRADE. ROOT BARRIERS SET PRIOR TO CONSTRUCTION MAY REQUIRE ADJUSTMENT LATER TO ENSURE FINAL LOCATION IS 2-INCHES BELOW FINISH GRADE. REFER TO SECTION 02950.
- 14. REFER TO CIVIL DWGS. FOR LAYOUT, QUANTITIES, SPECIES AND PLANTING DETAIL FOR STREET TREES.
- 15. REFER TO CIVIL/ARCH. SITE DWGS. FOR LAYOUT OF SITE WALLS & HARDSCAPE ELEMENTS AND FOR GRADING.
- 16. REFER TO CIVIL FOR LIMITS OF TREE PROTECTION. REFER TO SHT. L502 FOR TREE PROTECTION DETAIL.
- 17. NO PESTICIDES, HERBICIDES OR CHEMICAL FERTILIZERS SHOULD BE APPLIED TO VEGETATION AT THE SHORE PRECINCT.




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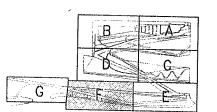
2 SECTOR F SHRUB, TURF A

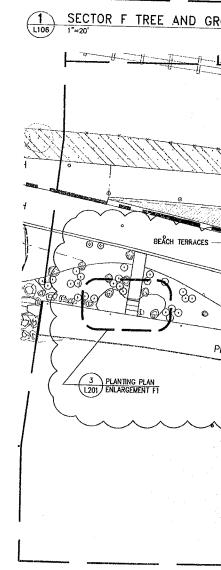

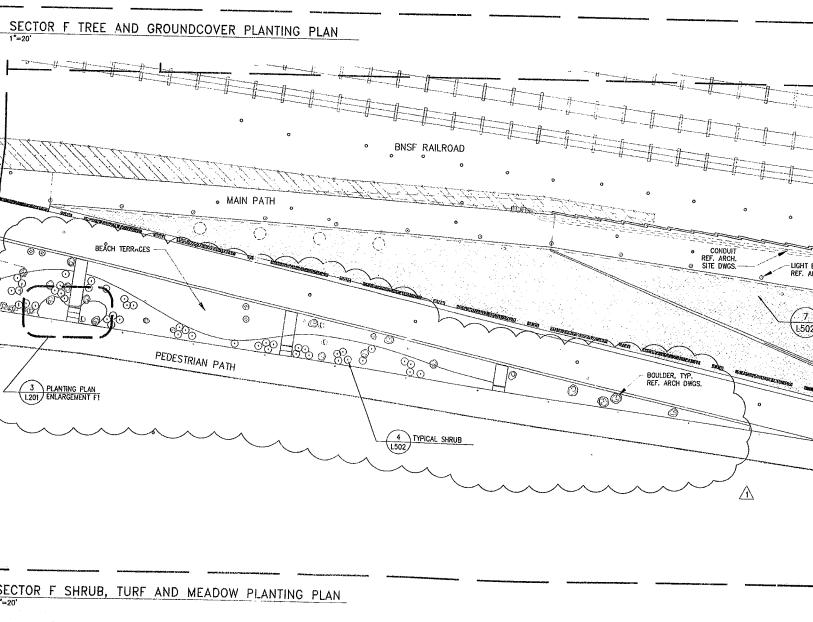

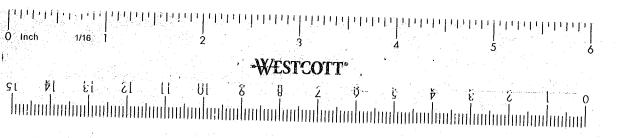ELLIOTT BAY



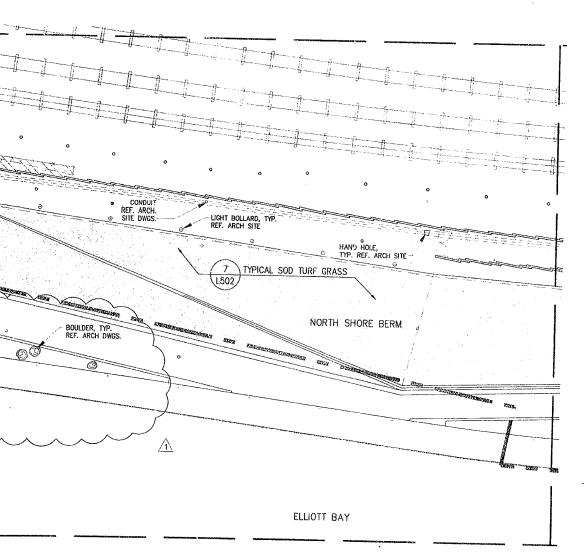

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AV/IT/Security Consultant ARUP 155 Avenue of the Americas New York, NY 10013 212.229.2669

Food Service Consultant JLR Design Group, Inc. 557 Roy Street, Suite 175-A Seattle, WA 98109 206.625.0070

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oue Dale Revisions

03.04.05 100% CONSTRUCTION DOCUMENTS

07.08.05 ASI #4

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DRAWING TITLE

PLANTING PLAN SECTOR F

Drawn SM/JP Date JULY 8, 2005 Checked CA Scale 1" = 20'

Drawing No.

1106



Document 100% CD CONFORMANCE SET

EES SYMBOL	BOTANICAL NAME	COMMON NAME	SIZE	SPACING
(+)	ALNUS RUBRA	RED ALDER	11/2" CAL.	AS SHOWN
(F)	CALOCEDRUS DECURRENS	INCENSE CEDAR	12' — 14' HT.	AS SHOWN
	PICEA SITCHENSIS	SITKA SPRUCE	6-8' HT.	AS SHOWN
	PINUS CONTORTA CONTORTA	SHORE PINE	4-6' HT.	AS SHOWN
B	PINUS CONTORTA CONTORTA	SHORE PINE	6-8' HT.	AS SHOWN
(1)	PSEUDOTSUGA MENZIESII	DOUGLAS FIR	6-8' HT.	AS SHOWN
The state of the s	THUJA PLICATA	WESTERN RED CEDAR	10-12' HT.	AS SHOWN
	ULMUS 'ACCODLADE'	ACCOLADE ELM	4" CAL.	AS SHOWN
RUBS SYMBOL	BOTANICAL NAME	COMMON NAME	SłZE	SPACING
0	ARCTOSTAPHYLOS COLUMBIANA	HAIRY MANZANITA	5 GAL.	AS SHOWN
0	MAHONIA AQUIFOLIUM	OREGON GRAPE	2 GAL.	AS SHOWN
Ø	MAHONIA NERVOSA	DULL OREGON GRAPE	2 GAL.	AS SHOWN
⊕	ROSA NUTKANA	NOOTKA ROSE	2 GAL.	
*	SYMPHORICARPOS ALBUS	SNOWBERRY		AS SHOWN
_			2 GAL.	AS SHOWN
· · · · · · · · · · · · · · · · · · ·	VACCINIUM OVATUM	EVERGREEN HUCKLEBERRY	2 GAL.	AS SHOWN
NT MIXES			_	
SYMBOL	BOTANICAL NAME	COMMON NAME	SIZE	SPACING
	FRAGARIA CHILOENSIS	BEACH STRAWBERRY	4" POT	36" O.C.
	GAULTHERIA SHALLON	SALAL	1 GAL.	48" O.C.
	ELYMUS MOLLIS	DUNE GRASS	PLUG	15" O.C.
المتناطعة المتناطعة	FRAGARIA CHILOENSIS	BEACH STRAWBERRY	4" POT	48" O.C.
	GRINDELIA INTEGRIFOLIA	PUGET SOUND GUMWEED	PLUG	48" O.C.
	LATHYRUS JAPONICUS	BEACH PEA	4" POT	48" O.C.
44444	FRAGARIA CHILOENSIS	BEACH STRAWBERRY	4" POT	24" O.C.
لمقتسما	FRAGARIA VIRGINIANA	WILD STRAWBERRY	4" POT	24" O.C.
	GAULTHERIA SHALLON	SALAL	1 GAL.	36" O.C.
RF				
SYMBOL	COMMON NAME			
	SOD TURF GRASS			

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- 4. ALL TREES SHALL HAVE HEALTHY AND STRONG CENTRAL LEADERS TO ENSURE OPTIMUM GROWTH AND SURVIVAL.
- AUGN ROWS OF TREES, SHRUBS AND GROUNDCOVER TO ADJACENT WALLS, PATHS, AND GRADE BREAKS UNLESS OTHERWISE NOTED.
- 6. ALL DIMENSIONS ARE TO CENTER OF TREE UNLESS OTHERWISE NOTED.

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7. REFER TO TYPICAL PLANTING DETAILS FOR SHRUBS, GROUNDCOVER, SOD TURF GRASS, MEADOW GRASS AND PLUGS ON SHEET L502 UNLESS OTHERMISE NOTED.


- 11. INSTALL TEMPORARY PROTECTION BARRIER ALONG PERIMETER OF ALL MEADOW AREAS TO PREVENT ACCESS AND DISTURBANCE TO MEADOW AREAS. BARRIER SHALL REMAIN IN PLACE UNTIL CRASS IS WELL ESTABLISHED AND EXHIBITS A VICOROUS GROWNIG CONDITION AS APPROVED BY LAMSSCAPE ARCHITECT. REFER TO SECTION 100110.
- 12. INSTALL TEMPORARY PROTECTION 2. JRIER ALONG PERIMETER OF ALL PLANTING AREAS AT SHORE PRECINCT AS SHOWN TO PREVENT ACCESS AND DISTURBANCE TO PLANTING AREAS. BAPRIER SHALL REMAIN IN PLACE UNIT. PLANTS ARE WELL ESTABLISHED OR UNTIL REMOVAL IS APPROVED BY OWNER. REFER TO SECTION 02930 2.6 & 3.8.
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- 14. REFER TO CIVIL DWGS. FOR LAYOUT, QUANTITIES, SPECIES AND PLANTING DETAIL FOR STREET TREES.
- 15. REFER TO CIVIL/ARCH. SITE DWGS. FOR LAYOUT OF SITE WALLS & HARDSCAPE ELEMENTS AND FOR GRADING.


START OF EXISTING BIKE P EXISTING TREES
TO REMAIN, TYP.
FOR TREE PROTECTION
AND FOR EXISTING
TREES, REF.
CIVIL DWGS. MYRTLE EDWARDS PARK COORDINATE ROOT BARRIER
WITH UNDERGROUND
UTILITIES, TYP. TYPICAL GROUNDCOVER 1502 SECTOR G TREE AND GROUND L107/ START OF EXISTING BIKE PA EXISTING TREES
TO REMAIN, TYP.
FOR TREE PROTECTION
AND FOR EXISTING
TREES, REF.
CIVIL DWGS. MYRTLE EDWARDS PARK TYPICAL SOD 7
TURF GRASS L502 COORDINATE ROOT BARRIER
WITH UNDERGROUND
UTILITIES, TYP.

5 L502

初国们。原

TYPICAL SHRUB

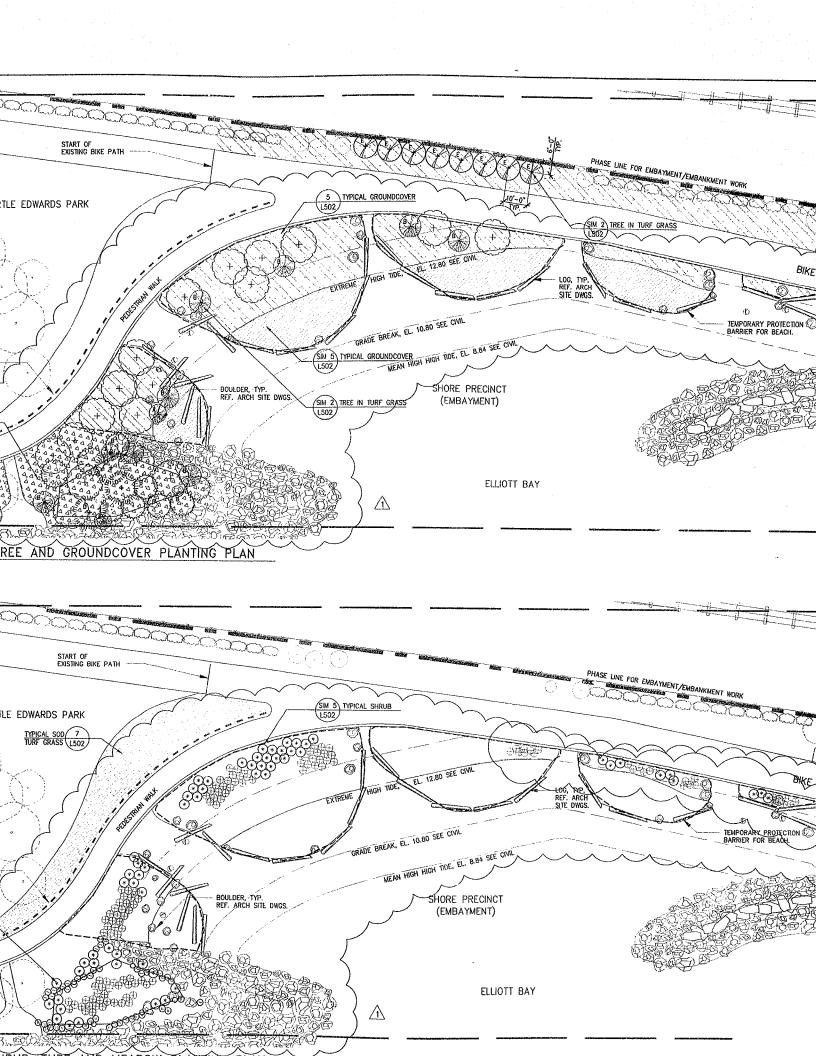

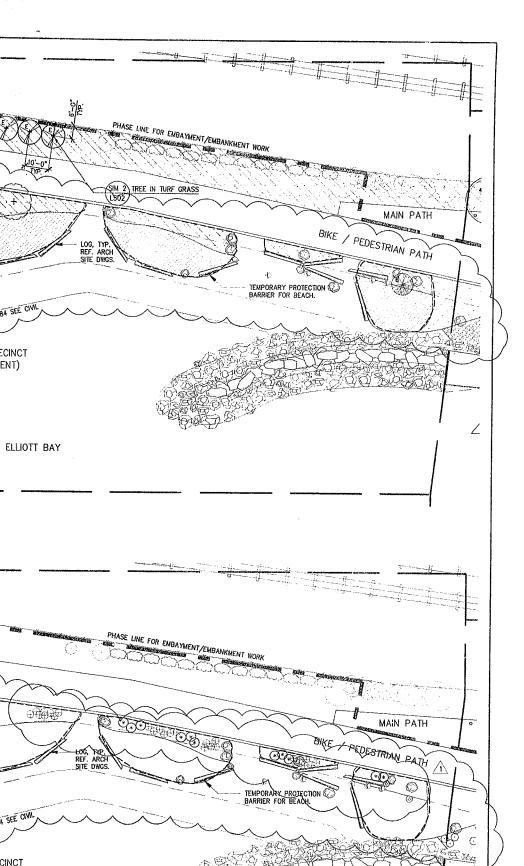

Olympic Sculpture Park

Seattle Art Museum Seattle, Washington 100 University Street Seattle, WA 98101

LEAD DESIGNER Site Design / Architecture Weiss / Manfredi Architects 130 West 29th Street, 12th floor New York, NY 10001 212,760,9002

CONSULTANT TEAM CONSULTANT TEAM
Structural & Civil Engineering Consultant
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AV/IT/Security Consultant ARUP
155 Avenue of the Americas New York, NY 10013 212.229.2669

Food Scrvice Consultant JLR Design Group, Inc. 557 Roy Street, Suite 175-A Seattle, WA 98109 206.625.0070

Construction Management Sellen Construction 227 Westlake Ave. N. Seattle, WA 98109 206.682.7770

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Issue Dote Revisions




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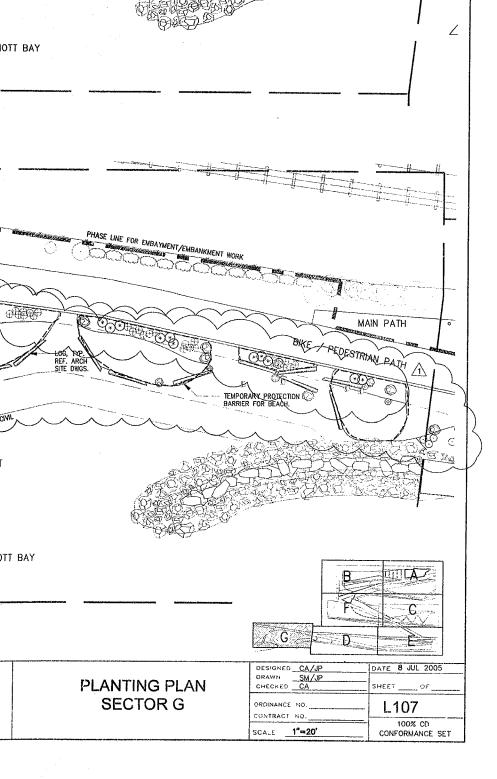


1 07.08.05 ASI #4

DRAWING HAS BEEN CLARIFIED W/ NO SCOPE CHANGE, UNLESS OTHERWISE NOTED BY REVISION CLOUD

Т	SHRUBS						GROUNDCOVER (L502)
.	SYMBOL	BOTANICAL NAME		COMMON NAME	SIZE	SPACING	334
1	∅	ARCTOSTAPHYLOS COLUMBIAN	IA	HAIRY MANZANITA	5 GAL.	AS SHOWN	I Table a day
	0	MAHONIA AQUIFOLIUM		OREGON GRAPE	2 GAL.	AS SHOWN	44444
	•	MAHONIA NERVOSA		DULL OREGON GRAPE	2 GAL.	AS SHOWN	24444
	⊕	ROSA NUTKANA		NOOTKA ROSE	2 GAL.	AS SHOWN	a de de
	*	SYMPHORICARPOS ALBUS		SNOWBERRY	2 GAL.	AS SHOWN	AND THE TOP OF THE PARTY OF THE
	⊙	VACCINIUM OVATUM		EVERGREEN HUCKLEBERRY	2 GAL.	AS SHOWN	SECTOR G TREE AND GR
	PLANT MIXES						
1.	SYMBOL	BOTANICAL NAME		COMMON NAME	SIZE	SPACING	
	Fee St	EDACADIA CUII OFNICIO		DELOU GENEVATORY			
	K-22-3	FRAGARIA CHILOENSIS		BEACH STRAWBERRY	4" POT	36" O.C.	
		GAULTHERIA SHALLON		SALAL	1 GAL.	48" O.C.	START
		ELYMUS MOLLIS		DUNE GRASS	PLUG	15" O.C,	EXISTING TREES EXISTING TO REMAIN, TYP.
	<u>15.6666.354</u>	FRAGARIA CHILOENSIS		BEACH STRAWBERRY	4" POT	48" O.C.	FOR TREE PROTECTION AND FOR EXISTING
		GRINDELIA INTEGRIFOLIA		PUGET SOUND GUMWEED	PLUG	48" O.C.	TREES, REF. CIVIL DWGS.
		LATHYRUS JAPONICUS		BEACH PEA	4" POT	48" O.C.	MYRTLE EDWARDS PAR
							TYPICAL SOD
	44444	FRAGARIA CHILOENSIS		BEACH STRAWBERRY	4" POT	24" O.C.	TURF GRASS L5
1		FRAGARIA VIRGINIANA		WILD STRAWBERRY	4" POT	24" O.C.	
		GAULTHERIA SHALLON		SALAL	1 GAL.	36" O.C.	~ 0.54270
	TURF						
-	SYMBOL	COMMON NAME					
		SOD TURF GRASS					
	ANTHON MATTER						COORDINATE ROOT BARRIER WITH UNDERGROUND
1.	ANTING NOTES: CONTRACTOR SHALL IRRIGATE	E ALL PROPOSED AND EXISTING PLANT MATER	BAL FOR	 REFER TO SHEET L401 FOR TYPE AND MULCH SHALL BE INSTALLED TO A DEXCEPT INSTALL NO MULCH AT SHORE PR 			UTILITIES, TYP.
1	IE DURATION OF THE PROJECT. CONTRACTOR IS REQUIRED TO		TRUCTION.				
1 (8	00-424-5555) AT LEAST 1WO	O VERIFY UTILITY LOCATIONS PRIOR TO CONSI UTILITIES UNDERGROUND LOCATION CENTER DAYS PRIOR TO CONSTRUCTION.		11. INSTALL TEMPORARY PROTECTION BAI AREAS TO PREVENT ACCESS AND DISTURE REMAIN IN PLACE UNTIL GRASS IS WELL E GROWING CONDITION AS APPROVED BY LAI	PANCE TO MEADOW AREAS. STABLISHED AND EXHIBITS	BARRIER SHALL A VIGOROUS	TYPICAL SHRUB 5
3. TH	PLANT MATERIALS SHALL ME E AMERICAN STANDARD FOR N	et standards set forth in the latest ec lursery stock (ansi–z60.1) and washingto	DITION OF ON STATE	02930.			1502
SI	andards for Nursery Stock Fficient root development Wtainer grown plant mater	URSERY STOCK (ANSI-Z60.1) AND WASHINGTI K, ORDER NO. 1627. ALL PLANT MATERIAL S TO ASSURE SURVIYAL AND HEALTHY GROWTH. MALS ARE REQUIRED TO HAVE SUFFICIENT RO	HALL HAVE	12. INSTALL TEMPORARY PROTECTION P.A. AREAS AT SHORE PRECINCT AS SHOWN TO PLANTING AREAS. BARRIER SHALL REMAIN) PREVENT ACCESS AND DI N IN PLACE UNTIL PLANTS	ISTURBANCE TO	
1 60	OWTH TO HOLD THE SOIL INTA IT BE ROOT BOUND.	CT WHEN REMOVED FROM THE CONTAINER, BU	JT SHALL	ESTABLISHED OR UNTIL REMOVAL IS APPR 2.6 & 3.8.	OVED BY OWNER. REFER 1	TO SECTION 02930	
4. OP	ALL TREES SHALL HAVE HEA TIMUM GROWTH AND SURVIVAL	LTHY AND STRONG CENTRAL LEADERS TO EN:	SURE	13. INSTALL ROOT BARRIER ALONG PERIM ROOT BARRIER 2—INCHES BELOW FINISH G CONSTRUCTION MAY REQUIRE ADJUSTMENT	ETER OF GROVE AREAS AS RADE. ROOT BARRIERS SE	S SHOWN. SET T PRIOR TO	The past of the pa
5. AN	ALIGN ROWS OF TREES, SHRL D GRADE BREAKS UNLESS OTH	JBS AND GROUNDCOVER TO ADJACENT WALLS JERWISE NOTED.	, PATHS,	2-INCHES BELOW FINISH GRADE. REFER 1 14. REFER TO CIVIL DWGS. FOR LAYOUT,	TO SECTION 02950.		
6.		HTER OF TREE UNLESS OTHERWISE NOTED.	nior	FOR SIREET IREES.			
1		DETAILS FOR SHRUBS, GROUNDCOVER, SOD IGS ON SHEET L502 UNLESS OTHERWISE NOTE		 REFER TO CIVIL/ARCH. SITE DWGS. FO ELEMENTS AND FOR GRADING. 			
8.	REFER TO SHEET L301 FOR A	JASTER PLANT SCHEDULE AND FIELD LOCATED) Plants.	16. REFER TO CIVIL FOR LIMITS OF TREE PROTECTION DETAIL.	PROTECTION, REFER TO SH	IT, L502 FOR TREE	2 SECTOR G SHRUB, TURF
				17. NO PESTICIDES, HERBICIDES OR CHEM VEGETATION AT THE SHORE PRECINCT.	ICAL FERTILIZERS SHOULD	BE APPLIED TO	£107 1"=20"
-	APPROVED F	OR ADVERTISING:			T		
		J. Nakotsu					
١,		cutive Administration	REVIEWED		DATE		n Landscape Architecture
٦	eattle, Washington	20	All work dans	in accordance with the City of Seattle Stor in effect on the date shown above, and su	ndard Plans and	T 206-5	la St Suite 301 Seattle, WA 98104
В	y: Director, Confi	racting Services Division	Special Provis	ions.	hhadraculan of	allp://ww	w.cherlesenderson.com
					1		•



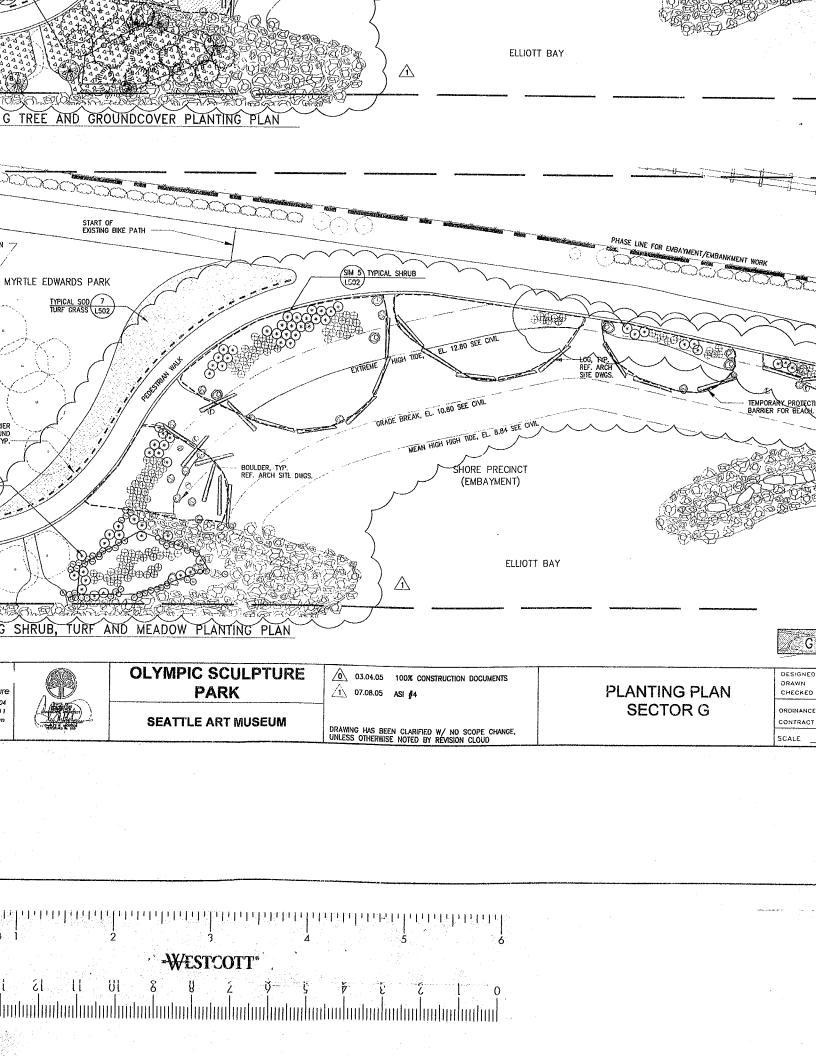

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Food Sr.vice Consultant JLR Design Group, Inc. 557 Roy Street, Suite 175-A Seattle, WA 98109 206.625.0070

Construction Management Sellen Construction 227 Westlake Ave. N. Seattle, WA 98109 206.682.7770

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Issue Date Revisions

03.04.05 100% CONSTRUCTION DOCUMENTS

1 07.08.05 ASI #4

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DRAWING TITLE

PLANTING PLAN SECTOR' G

Drawn SM/JP Date JULY 8, 2005 Checked CA Scale 1" = 20'

Drawing No.



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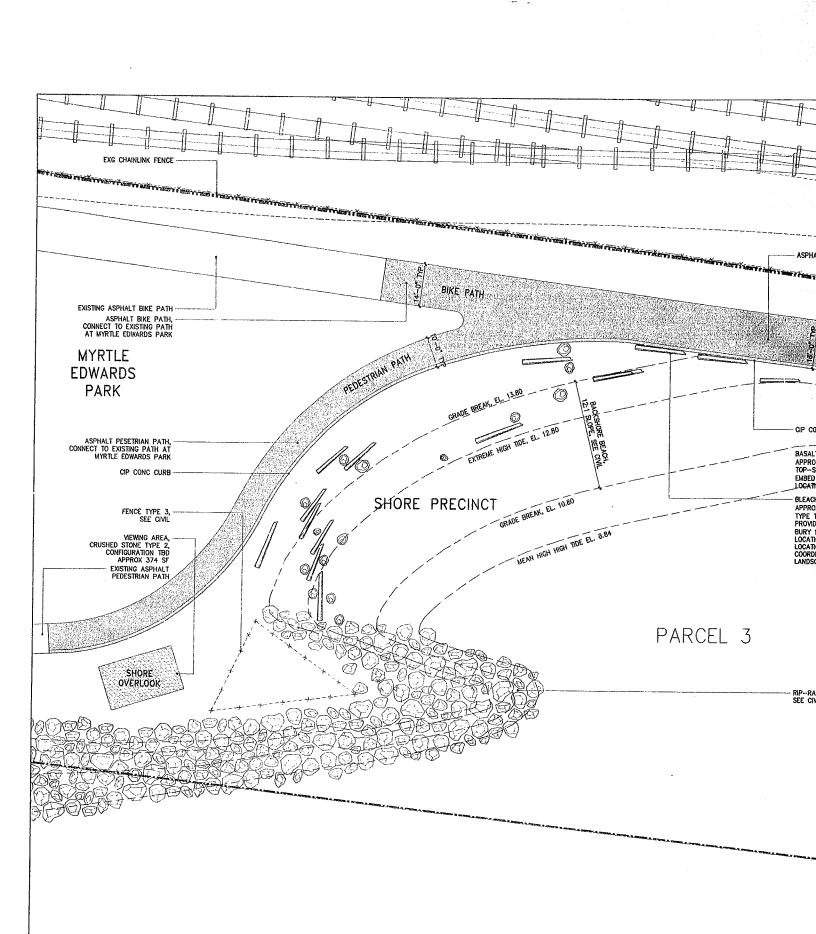


EXHIBIT Embayment I


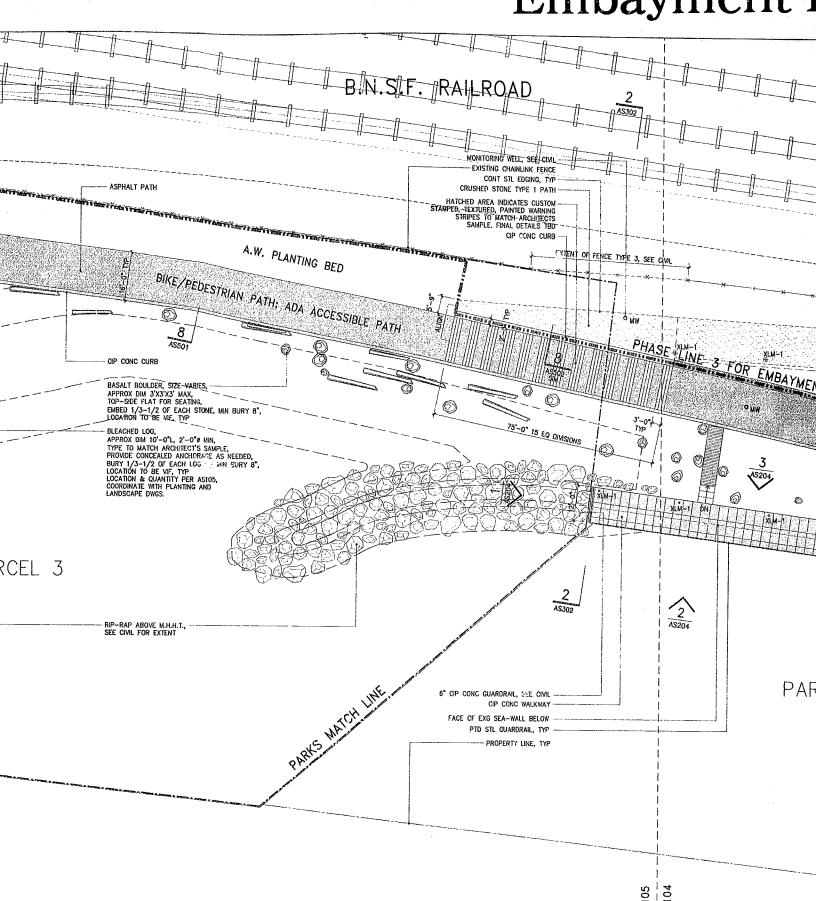


EXHIBIT D Embayment Plan

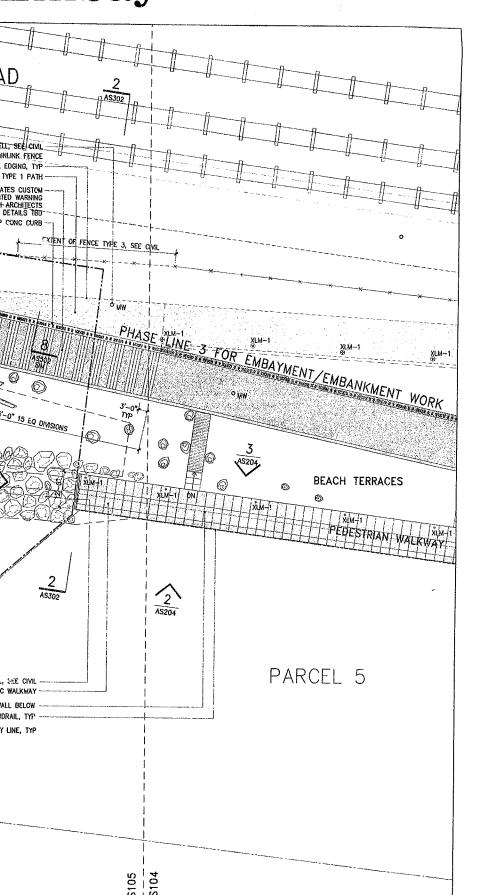

Olympic Sculpture Park

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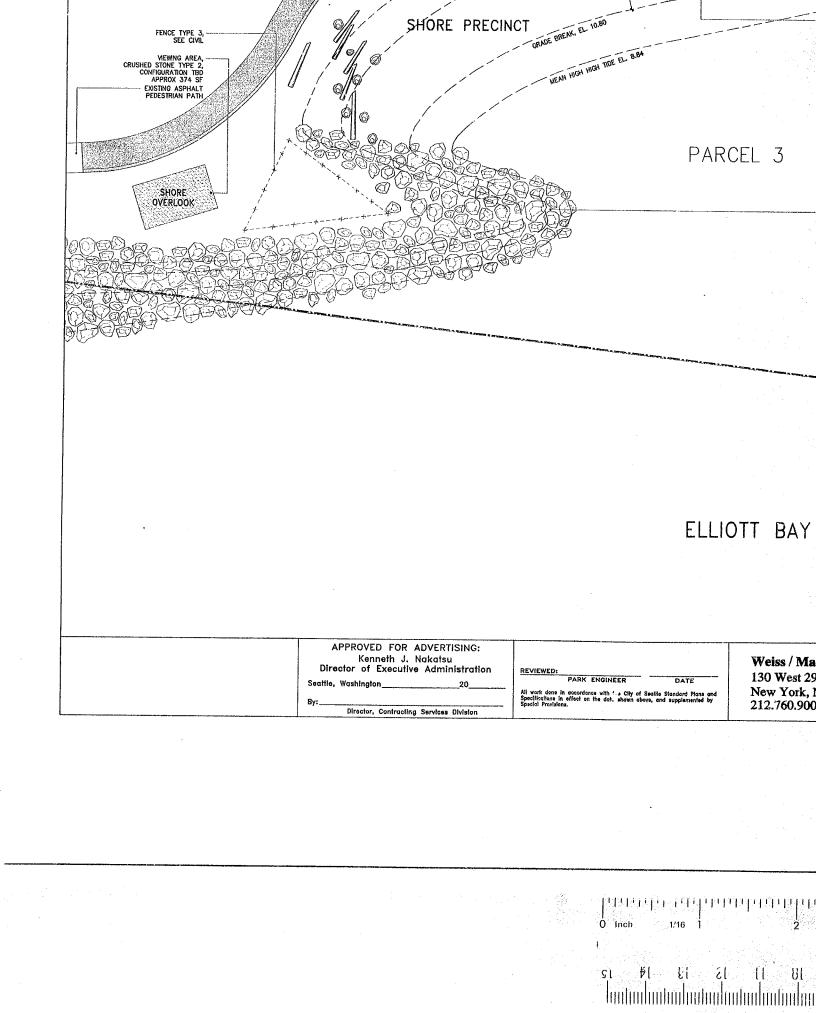
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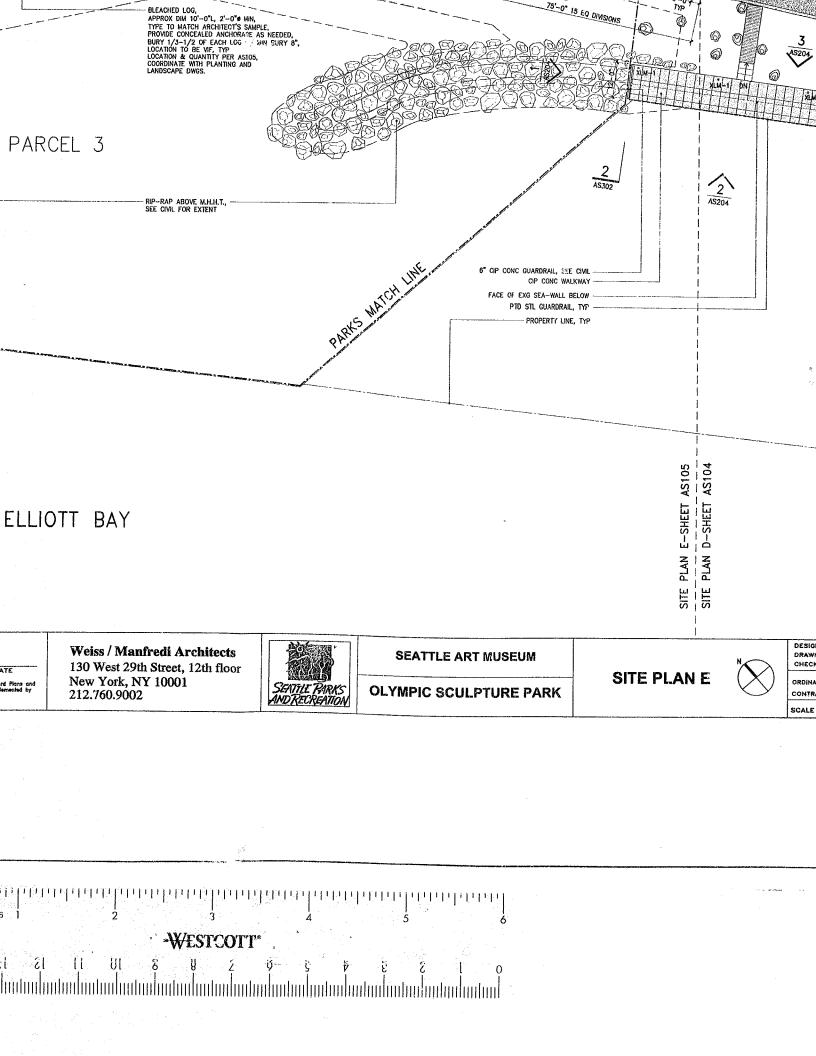
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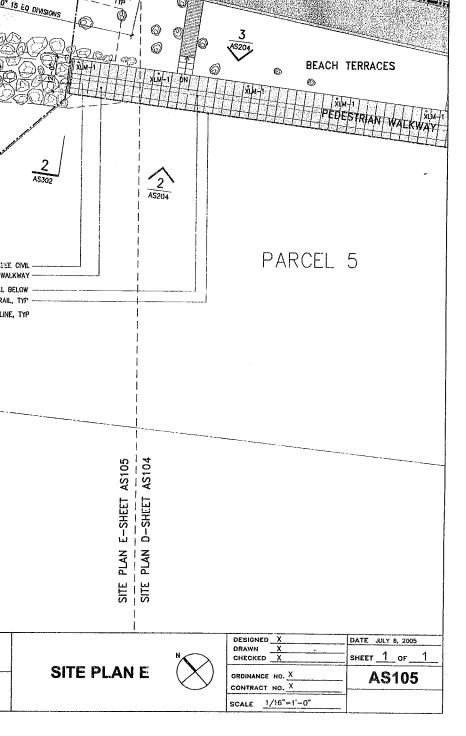
issue	Date	Revisions
<u> </u>	03.04.05	100% CONSTRUCTION DOCUMNTS
/1 \	07.08.05	ASI #4

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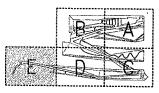
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	CRUSHED STONE PATH TYPE 1
	CRUSHED STONE PATH TYPE 2
	FIBAR PATH
2657 6 25784	CRUSHED STONE BASE STRIP
11.11	CONCRETE PAVING
(47 Ce) 11 11 1	ASPHALT
	GRADE BREAK
	STEEL EDGING
ENAMES STREET	PHASE MATCHLINE
	PARKS MATCHLINE
~ ~ ~ ~ ~	ART PROGRAM, N.I.C.
	PROPERTY LINE



DRAWING TITLE

SITE PLAN E

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Checked		Scale	1/1	6"	th	1'-0"	·
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							N

AS105




ocument 100% CD CONFORMANCE SET


Ordinance ja 1974

Sides KDIBIT C OFFICE STAPS

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EXHIBI



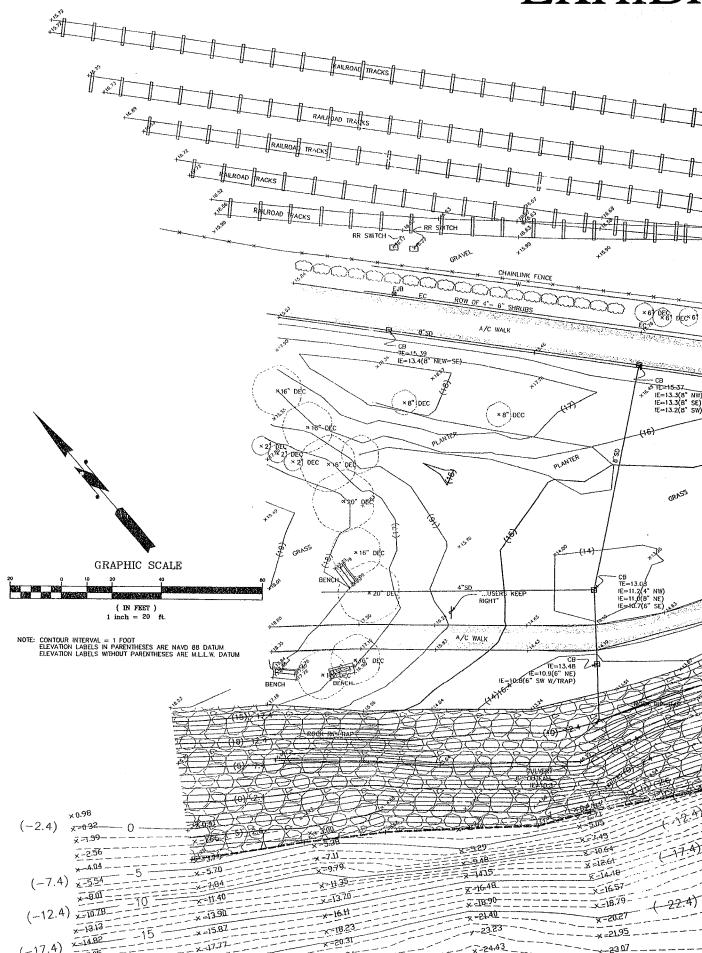

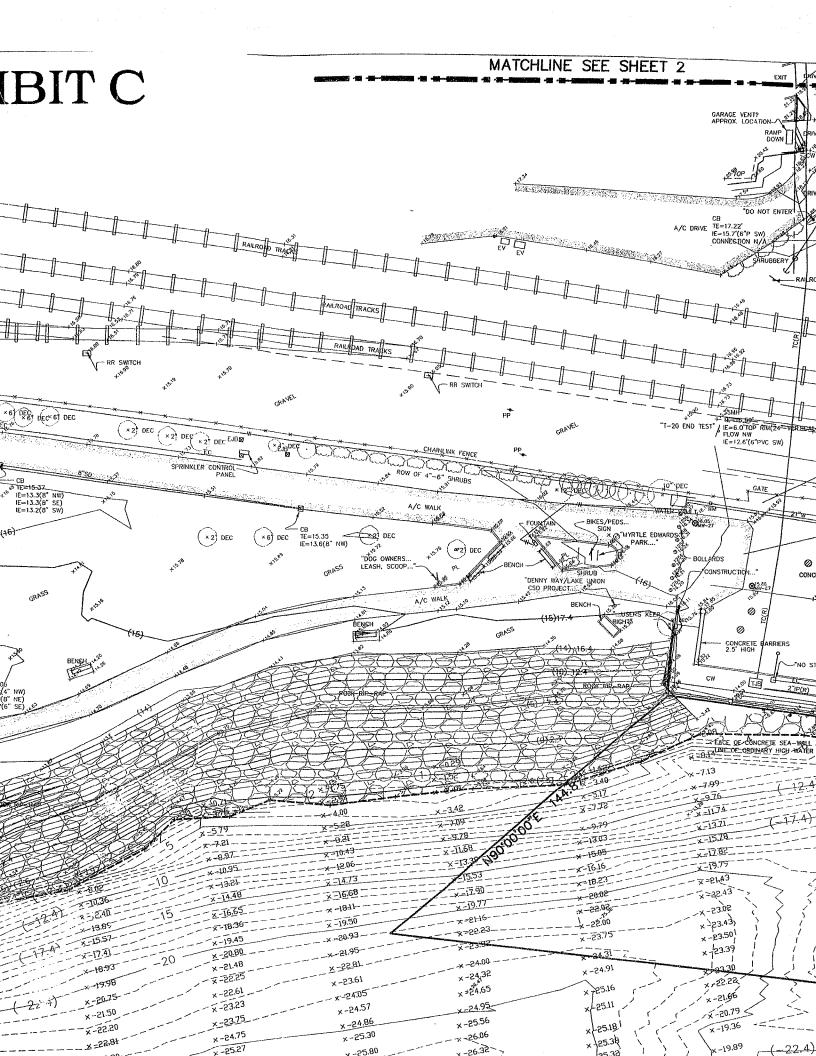2 GARAGE VENT? APPROX. LOCATION- ∞ ET END ROAD INF 1767 BHENTAGIEE) + TE-TD.59 / IE=6.0'TOP RIM(24-FLOW NW IE=12.6'(6"PVC SW) -20 END TEST EXTING CTION O" DEC GATE 0 6.05 W-27 BOI BOLLARDS CONSTRUCTIO CONCRETE DRIVE & PARKING Ø 0 0 CONCRETE 2.5' HIGH RRIERS 15.55 MONITOS 130 ्र चि -U.JC EACE OF CONCRETE SEA-WALL AT 18,07 **二亚亚** Z-19.79 48.56 x=2143 ×-18.16 _{>42.43}` -17.90 x=17.14 .23.02 -16.77 × 223.43) ×-23.50 ×-16.38 ×-16.09 × -23.39 ×-16.11 ×-22.22 -16.93 ×-17.45 ×-51.66 ×-18.15 ×-20.79 x -1868

x-19.34

x-20.25

x-19.36

-19,89

DRDIVAINE 121979

Olympic Sculpture Park

Seattle Art Museum Seattle, Washington 100 University Street Seattle, WA 98101

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		& SLOPE ANALYSIS ADDED
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LEGEND

AC ASPHALTIC CONCRETE	AC	ASPHALTIC	CONCRETE
-----------------------	----	-----------	----------

CB CATCH BASIN

CC CONCRETE CURB

CEDAR TREE SIZE AS NOTED

CONIFER TREE SIZE AS NOTED

CG CONCRETE GUTTER

CONCRETE SURFACE

DEC DECIDUOUS TREE SIZE AS NOTED

ELECTRICAL WIRES

ELECTRICAL CONDUIT

ECC EXTRUDED CONCRETE CURB

Ę۷ ELECTRICAL VAULT

FDC FIRE DEPARTMENT CONNECTION

-- FENCE (CHAIN LINK)

-//--//- FENCE (WOOD)

ዯ FIRE HYDRANT

FIBER OPTICS

FIBER OPTICS VAULT

GAS LINE

GAS VALVE

GUY POLE

GUY ANCHOR

HAND HOLE O LIGHT POLE

MONITOR WELL


O/H OVERHEAD

٩ PARKING METER

PL PLANTER

PM POWER METER


-O POWER POLE W/ LIGHT

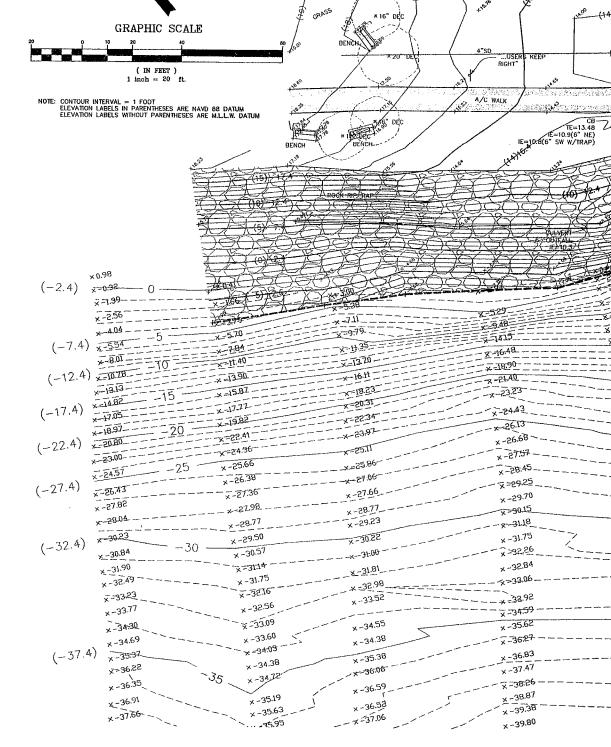







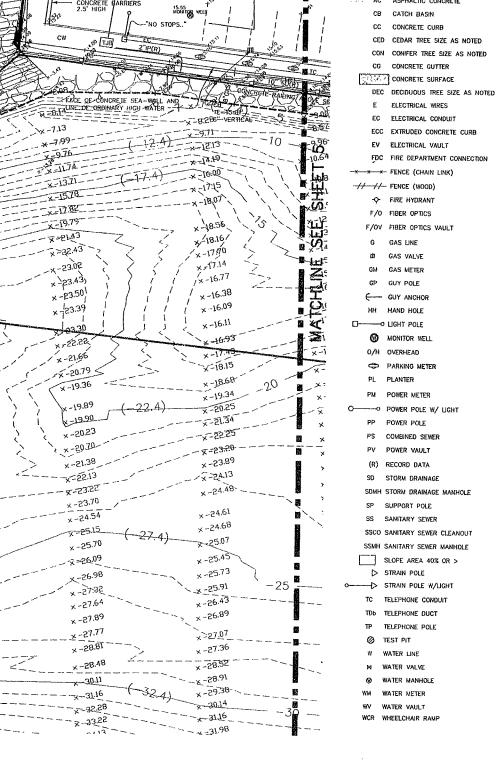

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DRAWING TITLE

BOUNDARY & TOPOGRAPHIC SURVEY OLYMPIC SCULPTURE PARK SEATTLE ART MUSEUM SEATTLE, KING COUNTY, WASHINGTON

DrawnREC/GLDDate JULY 27, 2004

Checked DCN Scale AS NOTED

Drawing No.

ing No.

4 OF

Document 50% CONSTRUCTION DOCUMENTS




2009 MINOR AVE. EAST SEATTLE, Washington 98102-3513 (206) 323-4144 1-800-935-0508 FAX# (206) 323-7135 E-MAIL: INFOGBRHINC COM







GRAPHIC SCALE

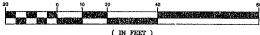

(IN FEET) 1 inch = 20 ft.

NOTE: CONTOUR INTERVAL == 1 FOOT ELEVATION LABELS IN PARENTHESES ARE NAVD 88 DATUM ELEVATION LABELS WITHOUT PARENTHESES ARE M.L.L.W. DATUM

LEGEND

- AC ASPHALTIC CONCRETE
- CB CATCH BASIN
- CC CONCRETE CURB
- CCD CEDAR TREE SIZE AS NOTED
- CON CONIFER TREE SIZE AS NOTED
- CG CONCRETE GUTTER

CONCRETE SURFACE

- DEC DECIDUOUS TREE SIZE AS NOTED
- E ELECTRICAL WIRES
- EC ELECTRICAL CONDUIT
- ECC EXTRUDED CONCRETE CURB
- EV ELECTRICAL VAULT
- FDC FIRE DEPARTMENT CONNECTION

-x x x FENCE (CHAIN LINK)

// // FENCE (WOOD)


-Q- FIRE HYDRANT

F/OV FIBER OPTICS VAULT

- G GAS LINE
- D GAS VALVE
- M GAS METER





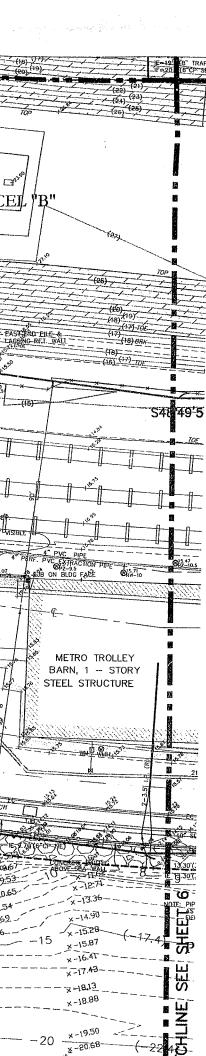

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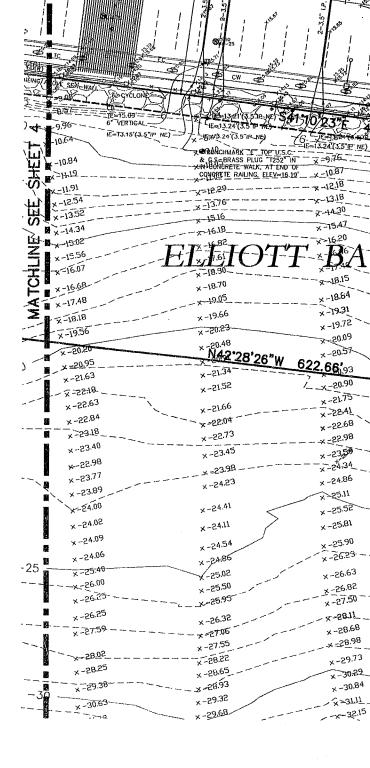
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(IN FEET)
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LEGEND ASPHALTIC CONCRETE AC CB CATCH BASIN CONCRETE CURB CC CEDAR TREE SIZE AS NOTED CED CON CONIFER TREE SIZE AS NOTED CG CONCRETE GUTTER CONCRETE SURFACE DEC DECIDUOUS TREE SIZE AS NOTED E ELECTRICAL WIRES ELECTRICAL CONDUIT EC ECC EXTRUDED CONCRETE CURB ELECTRICAL VAULT FIRE DEPARTMENT CONNECTION FENCE (CHAIN LINK) //- FENCE (WOOD) FIRE HYDRANT FIBER OPTICS FIBER OPTICS VAULT GAS LINE GAS VALVE GAS METER GUY POLE GUY ANCHOR HAND HOLE нн O LIGHT POLE 0 MONITOR WELL OVERHEAD O/H PARKING METER ٩ РМ POWER POLE W/ LIGHT POWER POLE STORM DRAINAGE SDMH STORM DRAINAGE MANHOLE SUPPORT POLE \$5 SANITARY SEWER SSCO SANITARY SEWER CLEANOUT SSMH SANITARY SEWER MANHOLE SLOPE AREA 40% OR > > STRAIN POLE STRAIN POLE W/LIGHT TELEPHONE CONDUIT TDb TELEPHONE DUCT TP TELEPHONE POLE TEST PIT 0 WATER LINE WATER MANHOLE WATER METER




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WATER VAULT WHEELCHAIR RAMP





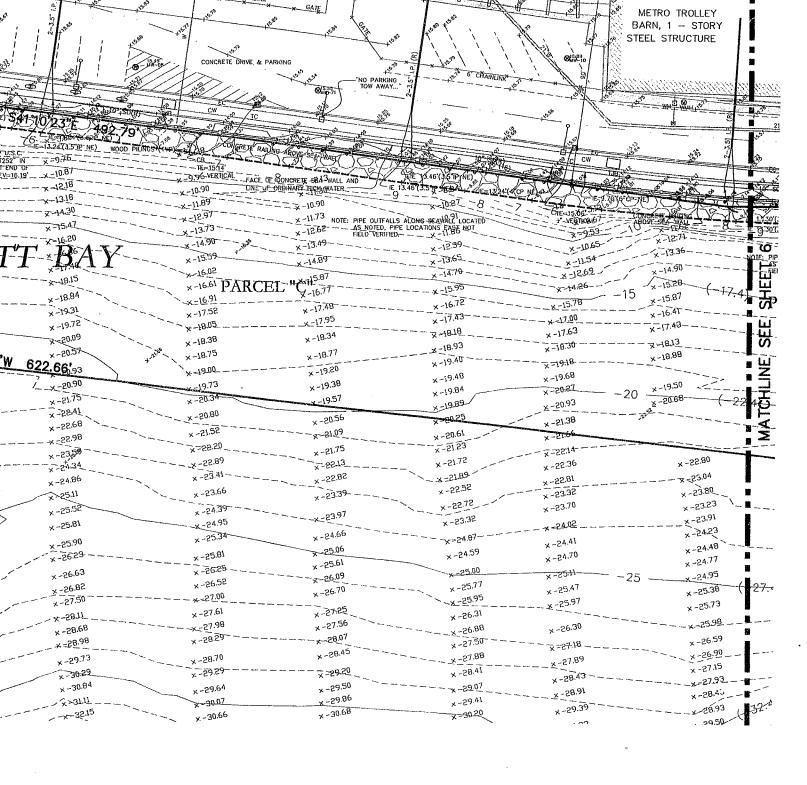



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1	11-19-02	UTILITY REVISIONS
2	02-04-03	REVISED PER COMMENTS
3	05-12-04	ADDED TOPO IN APRK
4	06-02-04	ADDED BATHYMETRIC DATA
5	10-21-04	ADDED ON-SITE GRADING AFTER FILL OPERATIONS
6	06-10-05	REVISED PER SDOT COMMENTS & SLOPE ANALYSIS ADDED

DRAWING TITLE

BOUNDARY & TOPOGRAPHIC SURVEY OLYMPIC SCULPTURE PARK SEATTLE ART MUSEUM SEATTLE, KING COUNTY, WASHINGTON

DrawnREC/GLDDote JULY 27, 2004 Checked DCN Scale AS NOTED
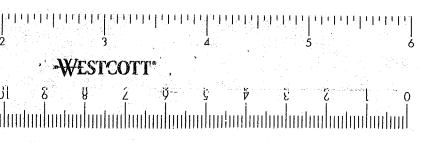
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CIVIL ENGINEERS & LAND SURVEYORS

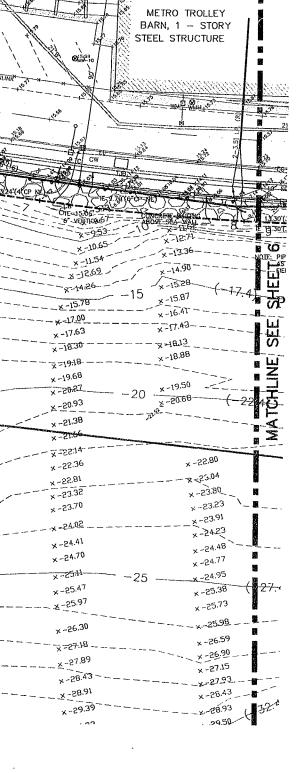
2009 MINOR AVE. EAST SEATTLE, Washington 98102-3513

(206) 323-4144 1-800-935-0508 FAX# (206) 323-7135 E-MAIL: INFO@BRHINC.COM







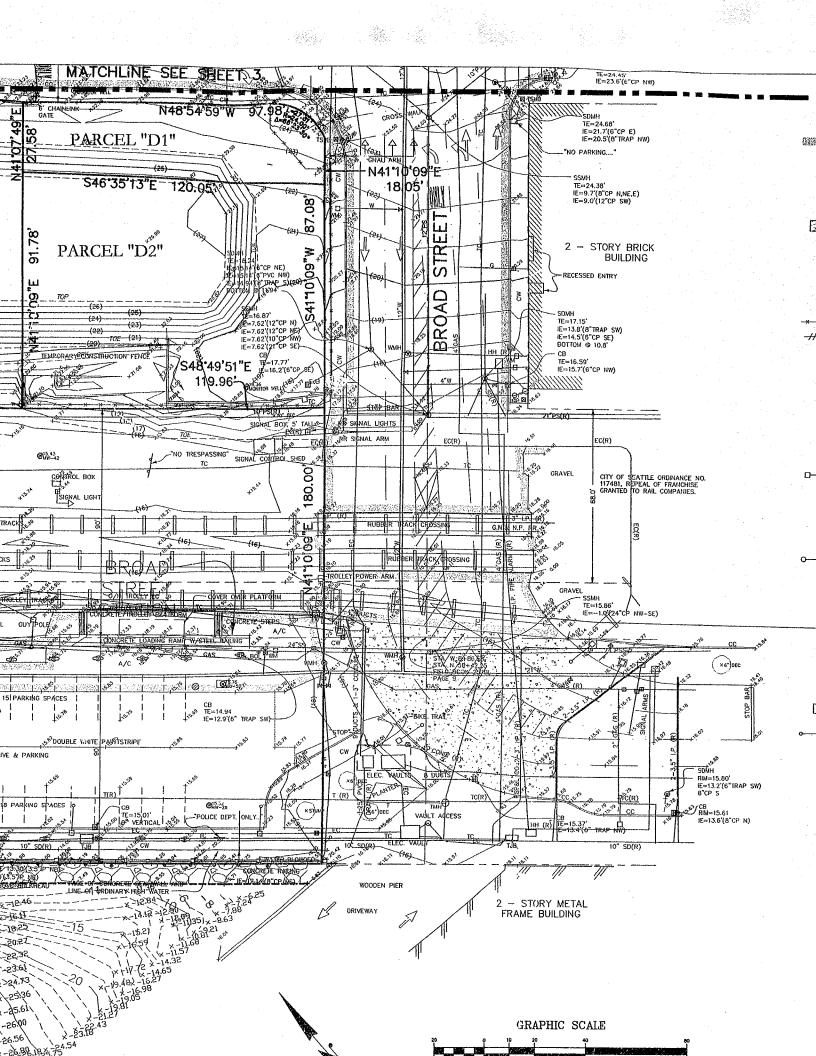

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Olympic Sculpture Park

Seattle Art Museum Scattle, Washington 100 University Street Seattle, WA 98101

LEAD DESIGNER Site Design / Architecture Weiss / Manfredi Architects 130 West 29th Street, 12th floor New York, NY 10001 212,760,9002

CONSULTANT TEAM
Structural & Civil Engineering Consultant
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Seattle, WA 98101
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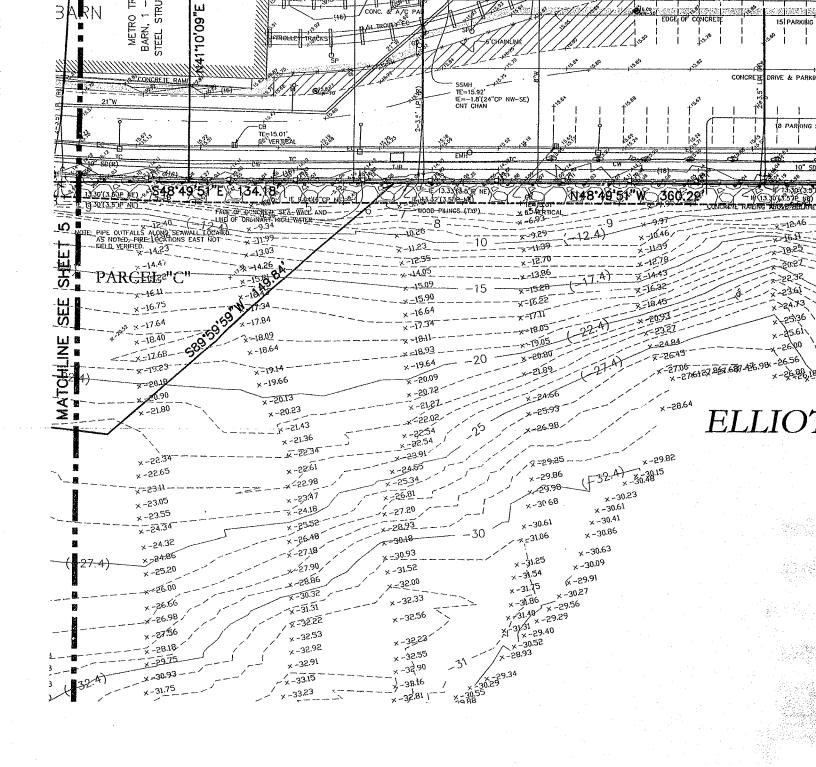
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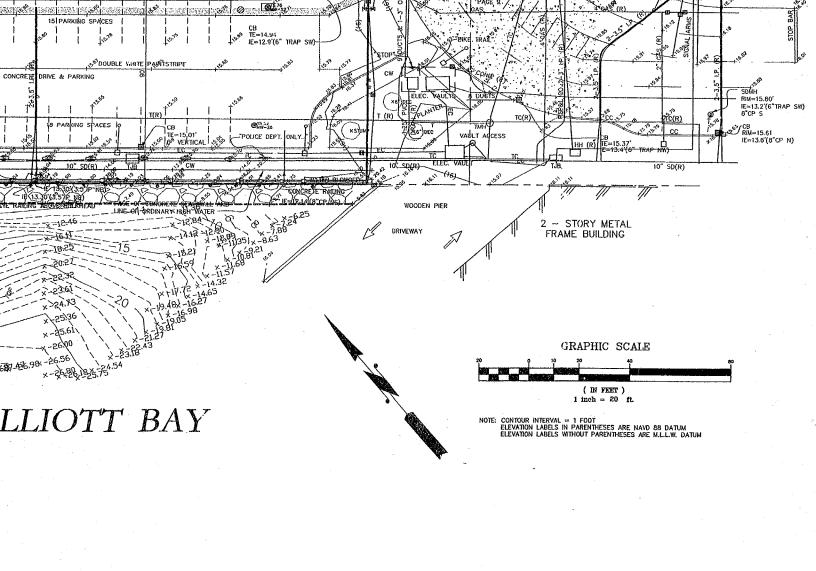
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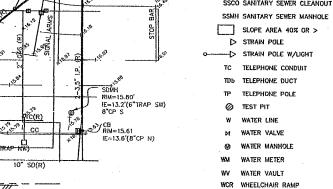


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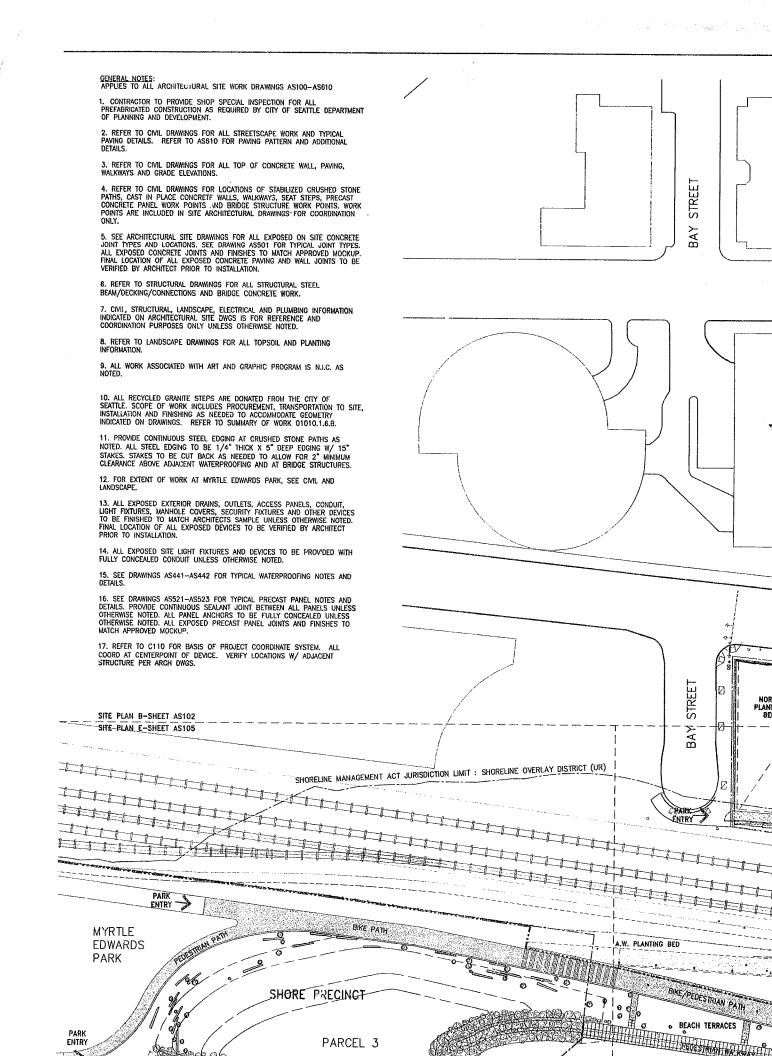
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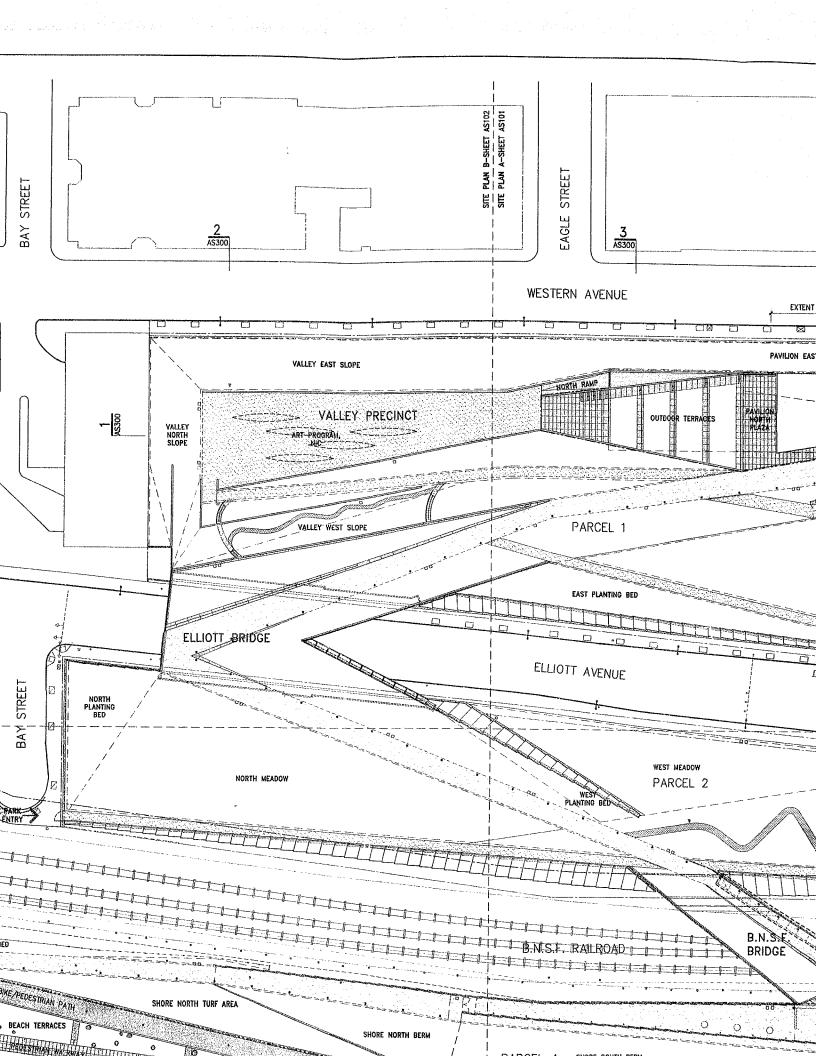
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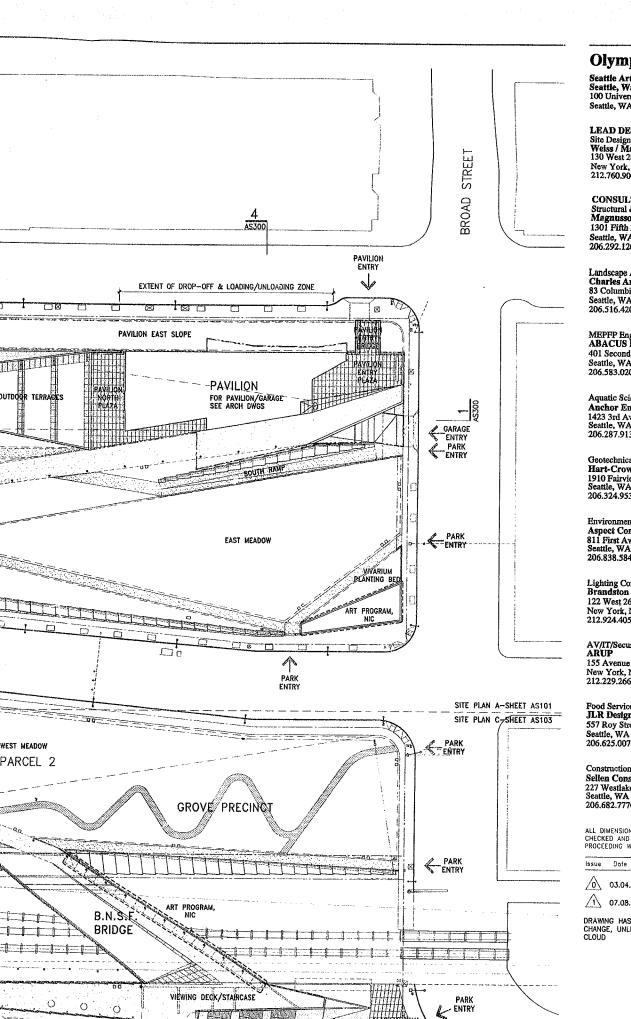
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Olympic Sculpture Park

Seattle Art Museum Seattle, Washington 100 University Street Seattle, WA 98101

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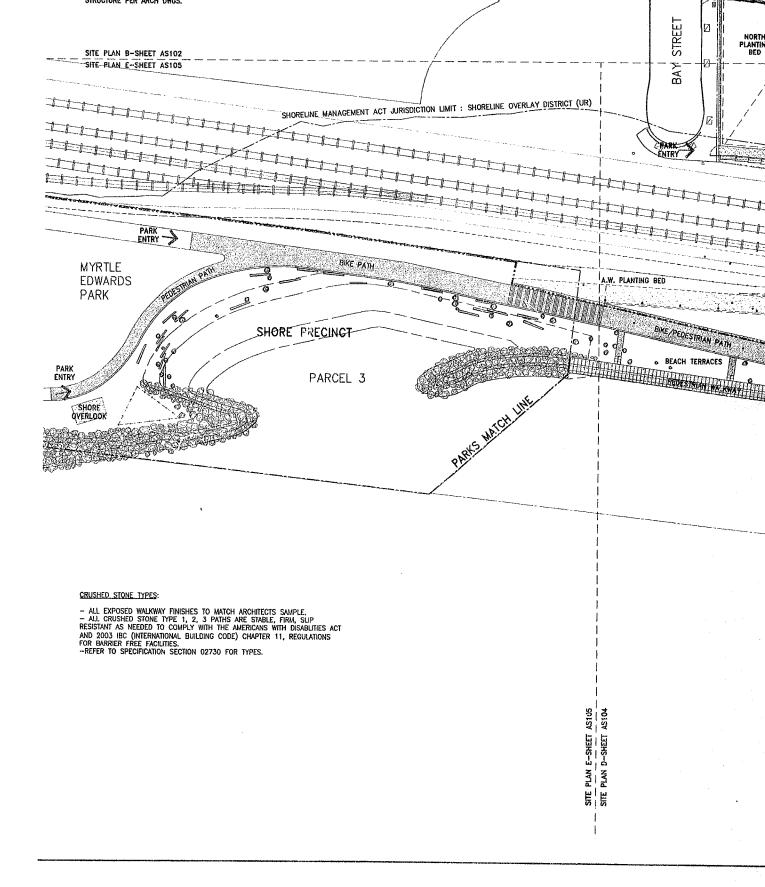
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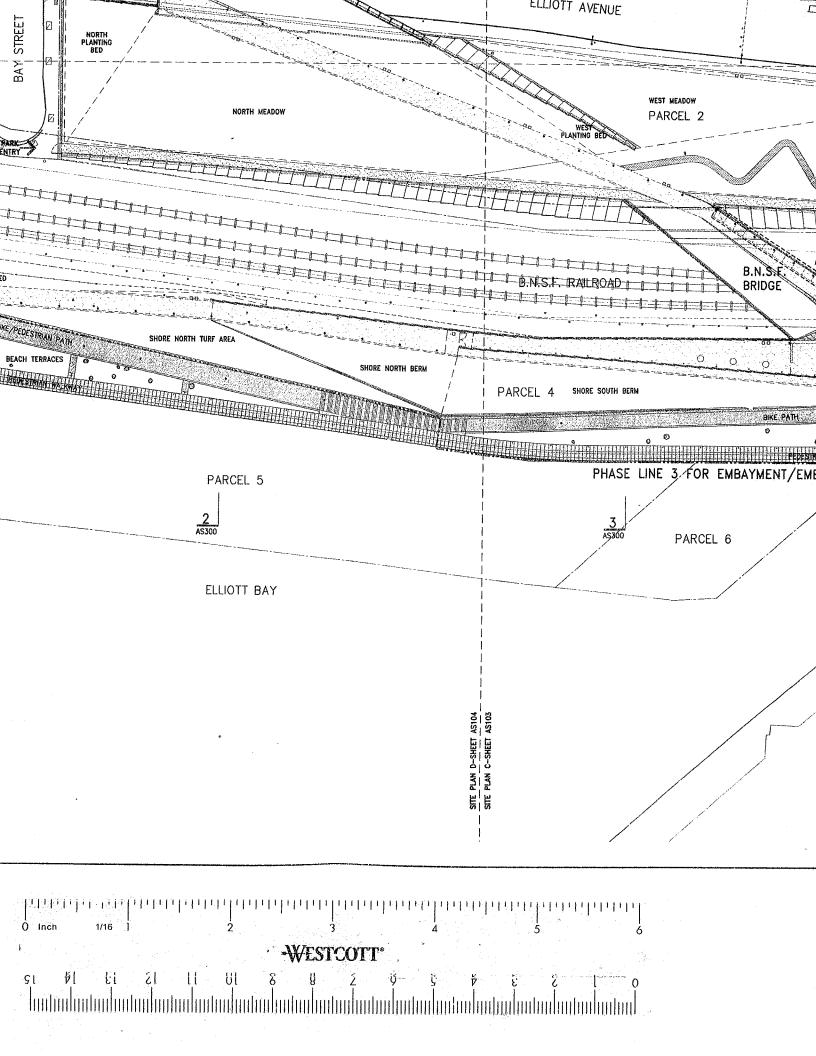
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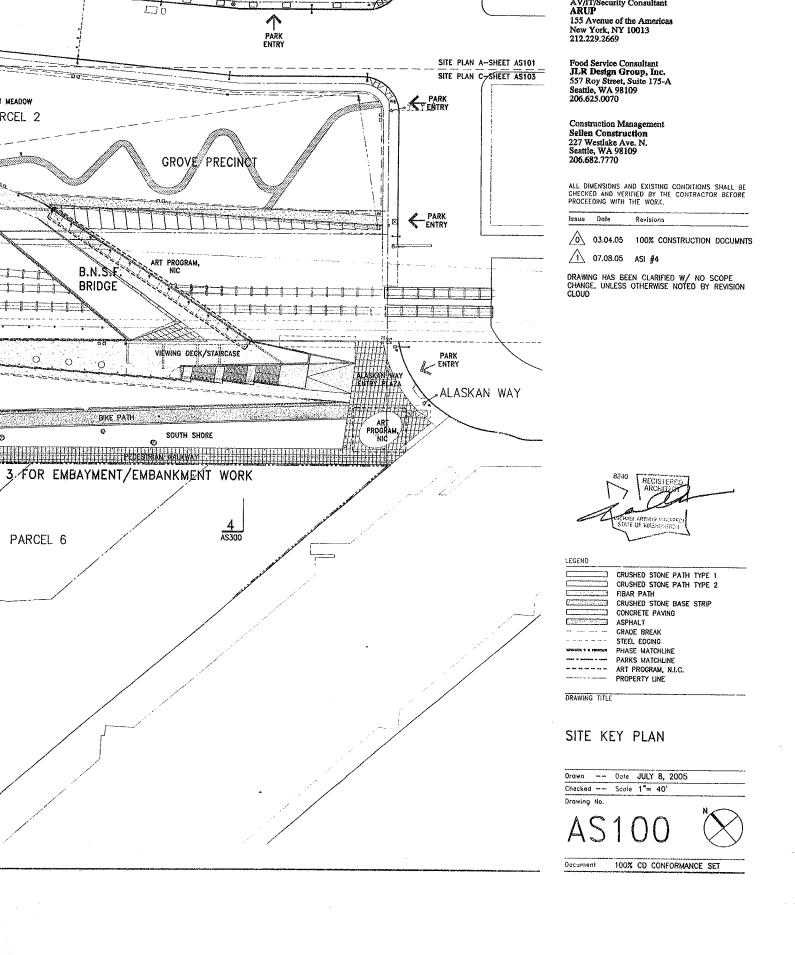
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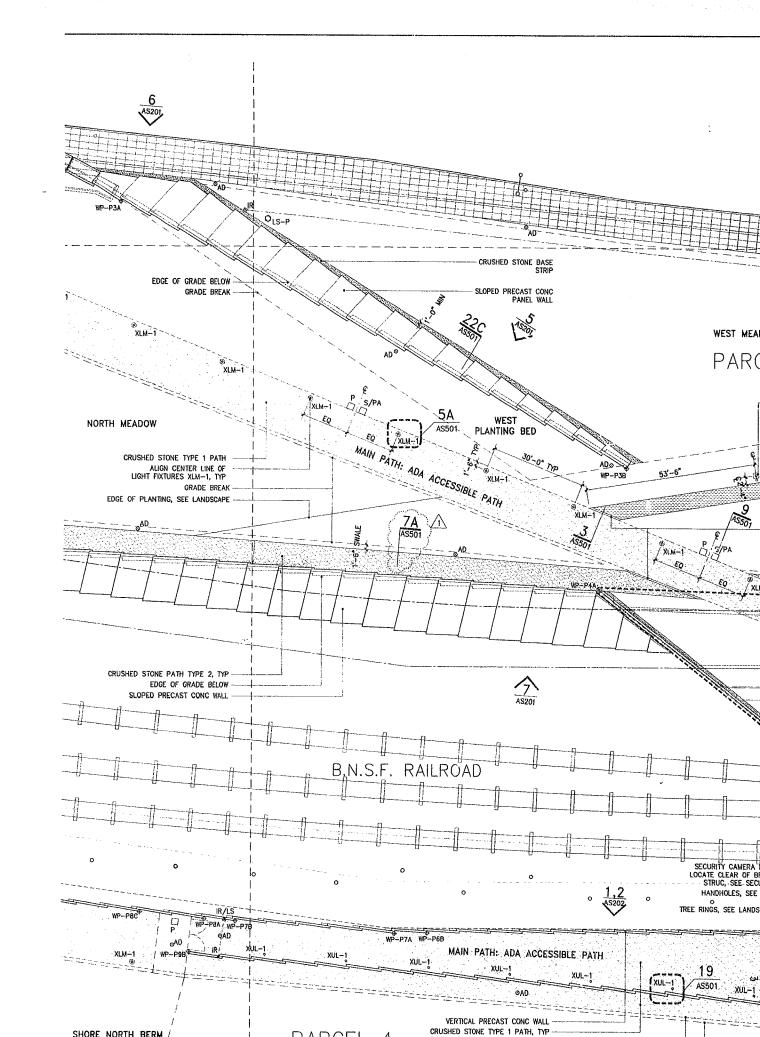
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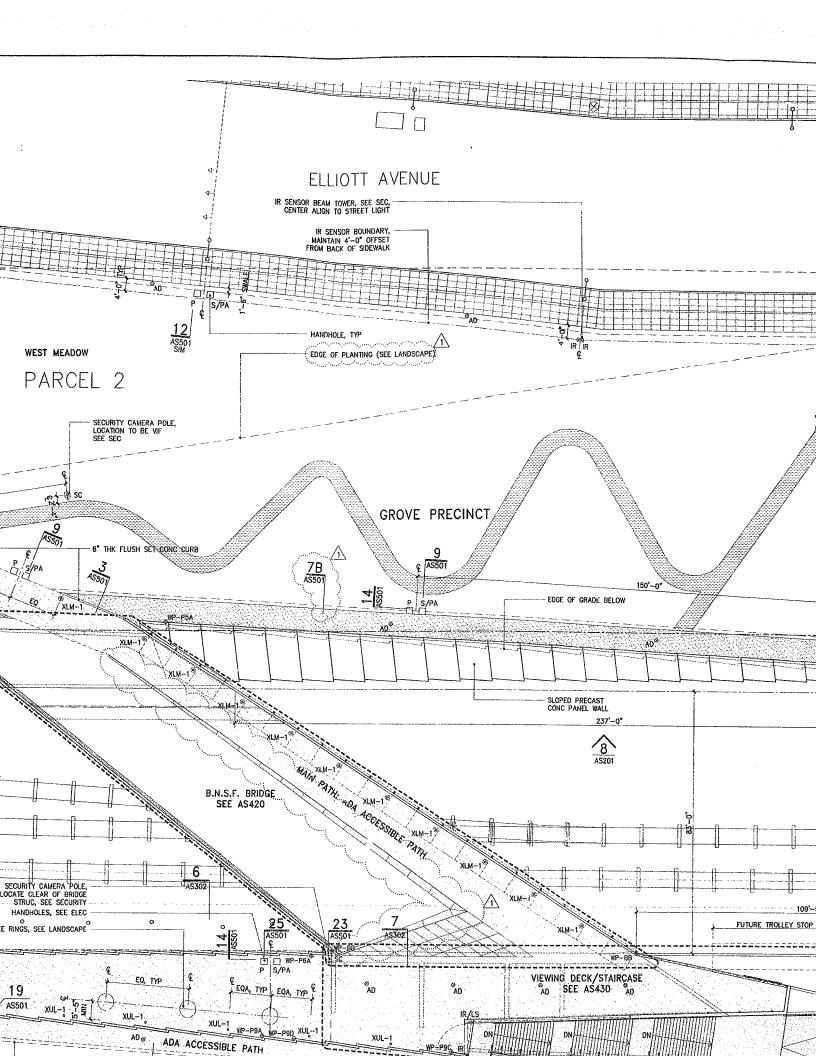


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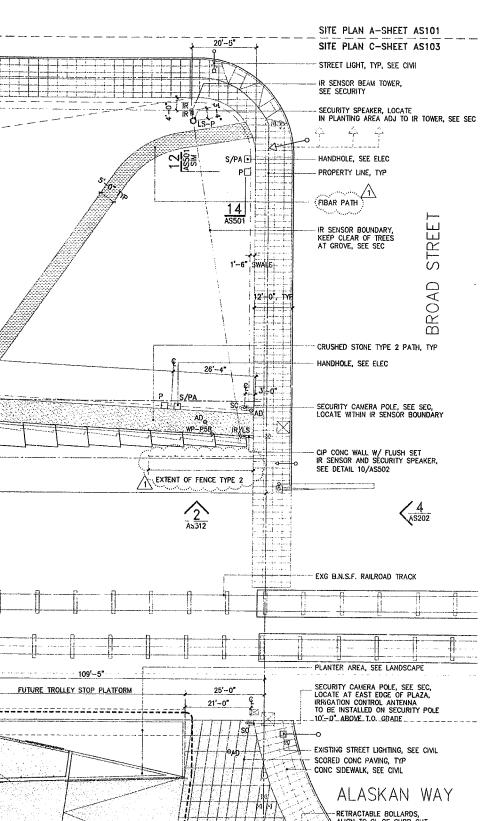












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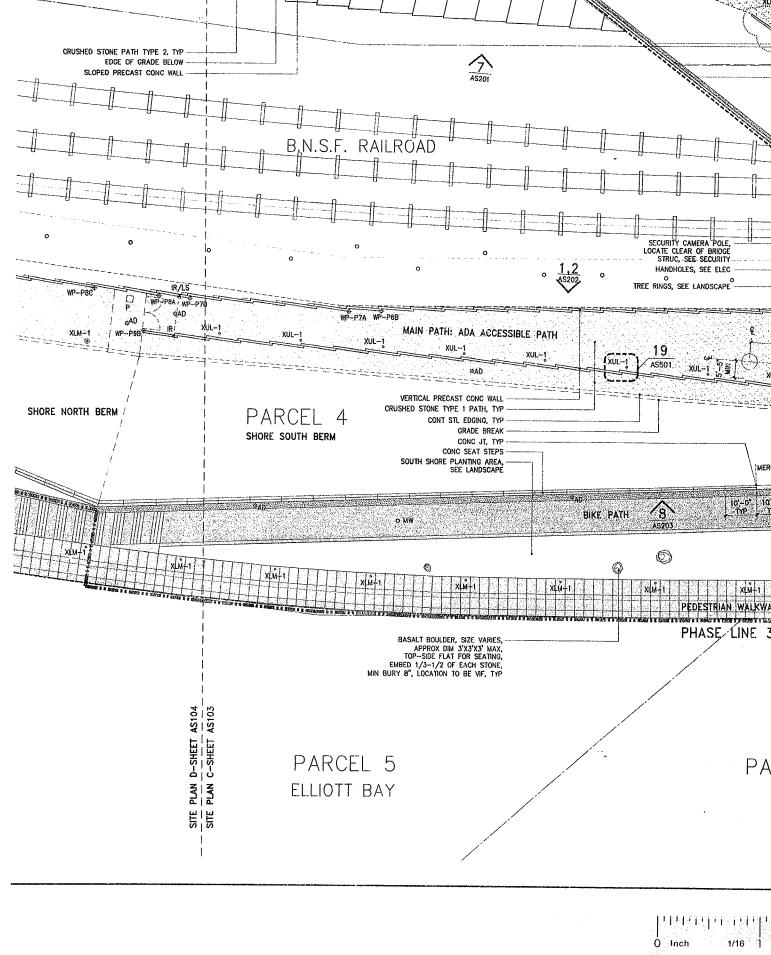
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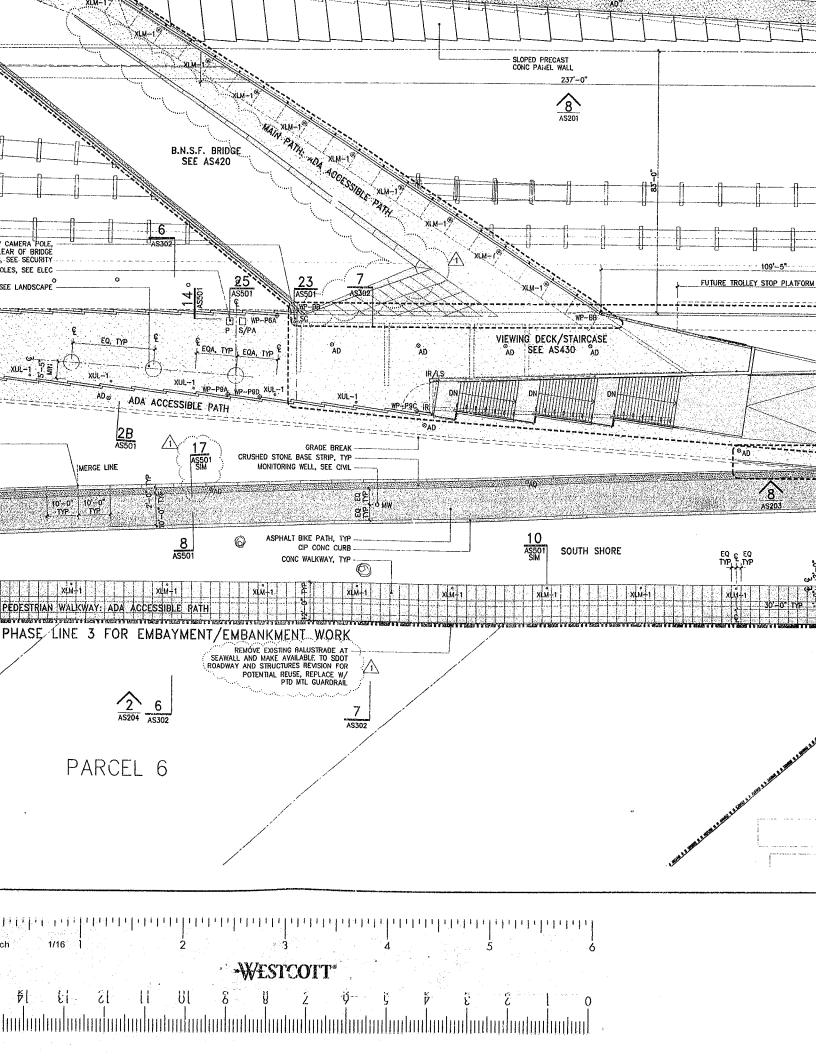
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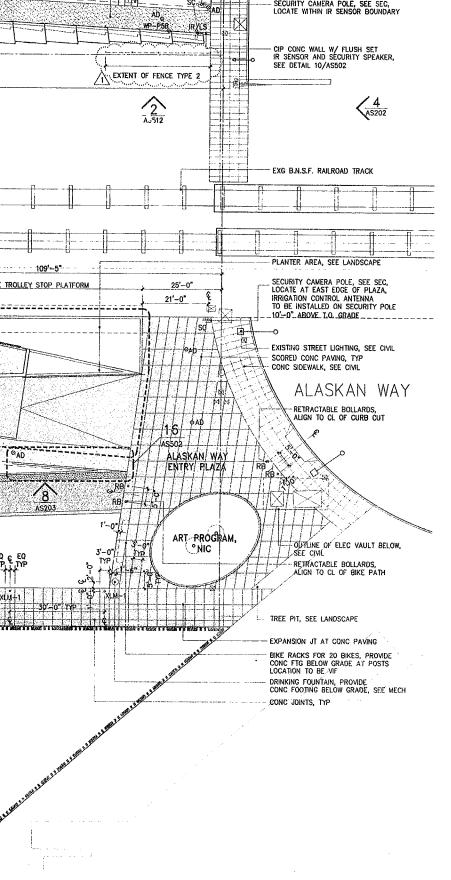
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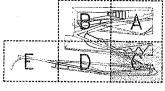
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STEEL EDGING
PHASE MATCHLINE
PARKS MATCHLINE
ART PROGRAM, N.I.C.
PROPERTY LINE



DRAWING TITLE

SITE PLAN C


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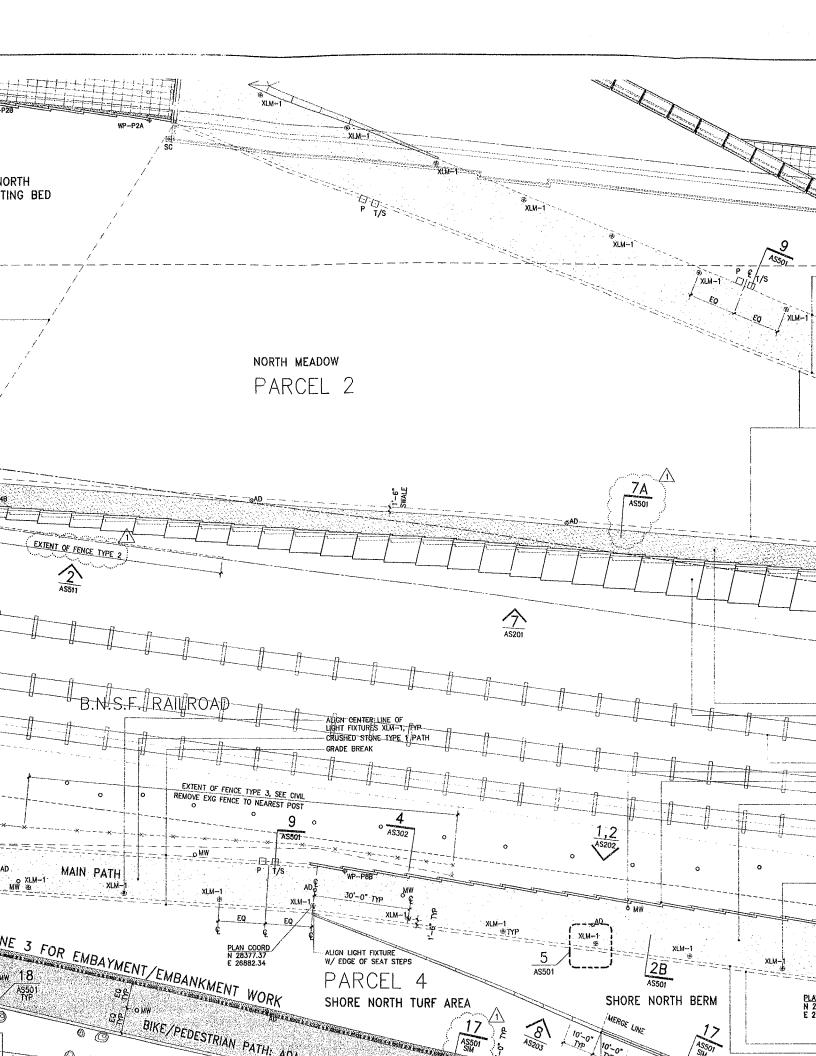
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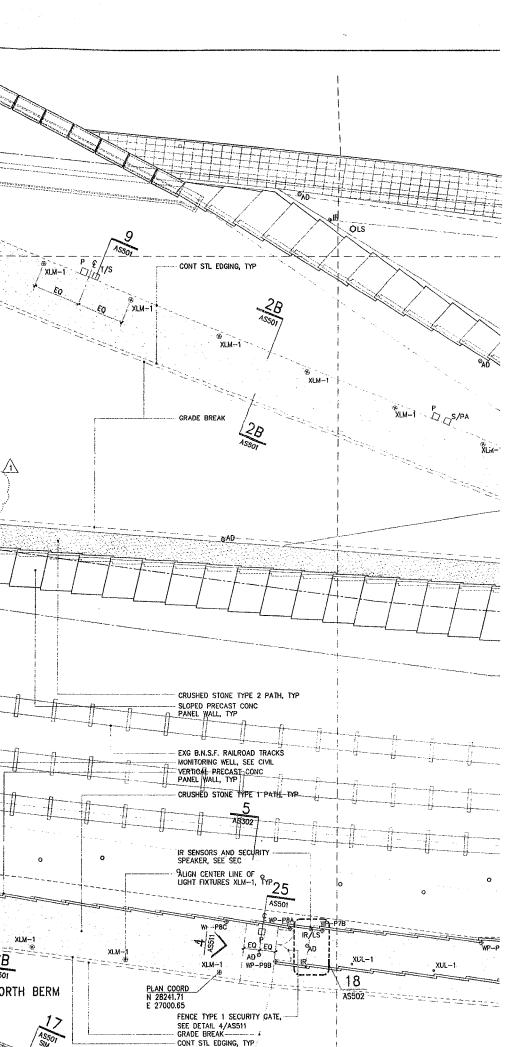
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Seattle Art Museum Seattle, Washington 100 University Street Seattle, WA 98101

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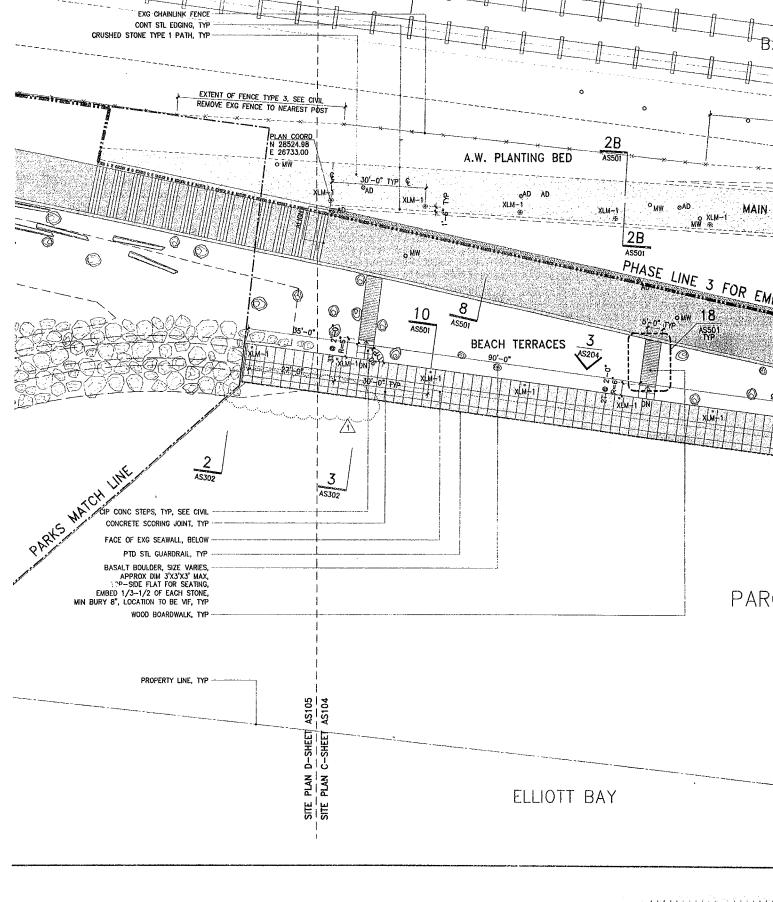
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<u></u>	03.04.05	100% CONSTRUCTION DOCUMNTS		
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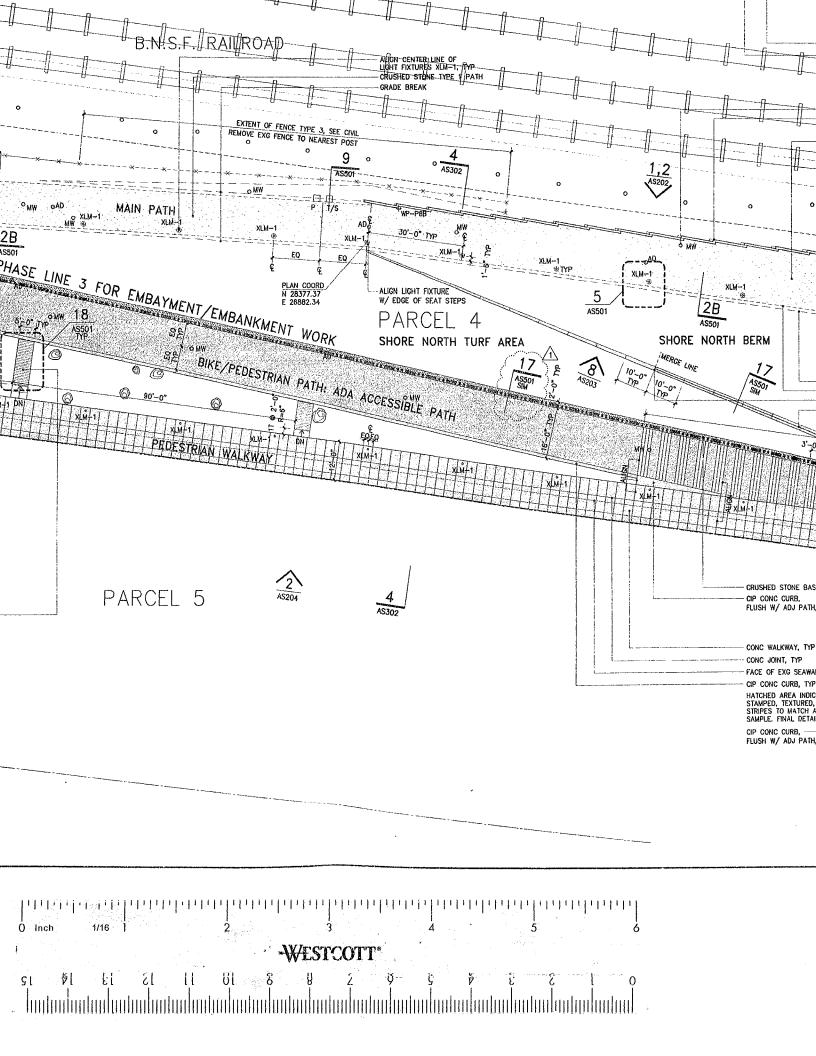
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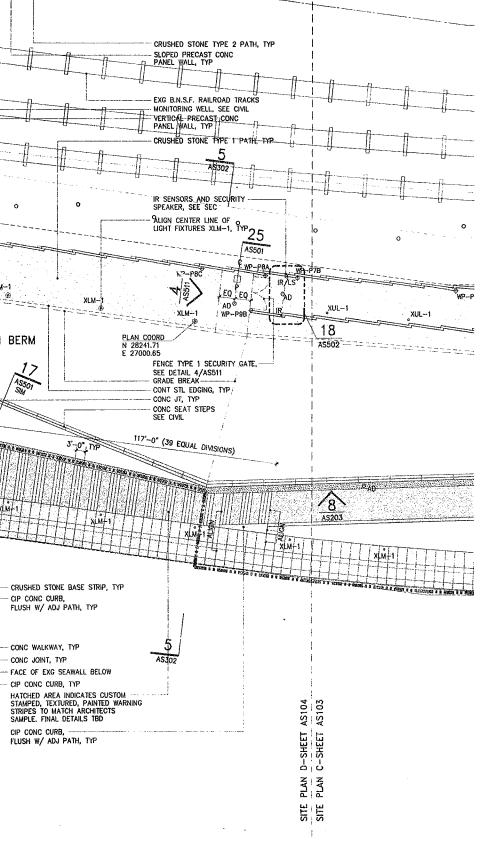
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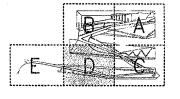
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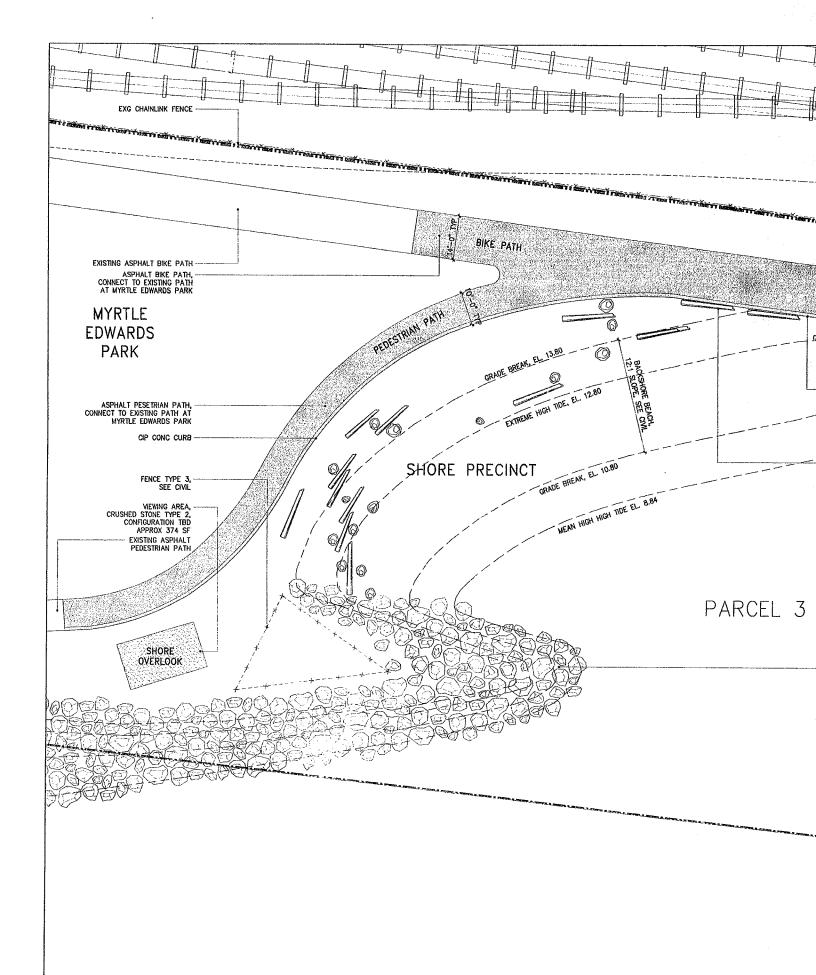
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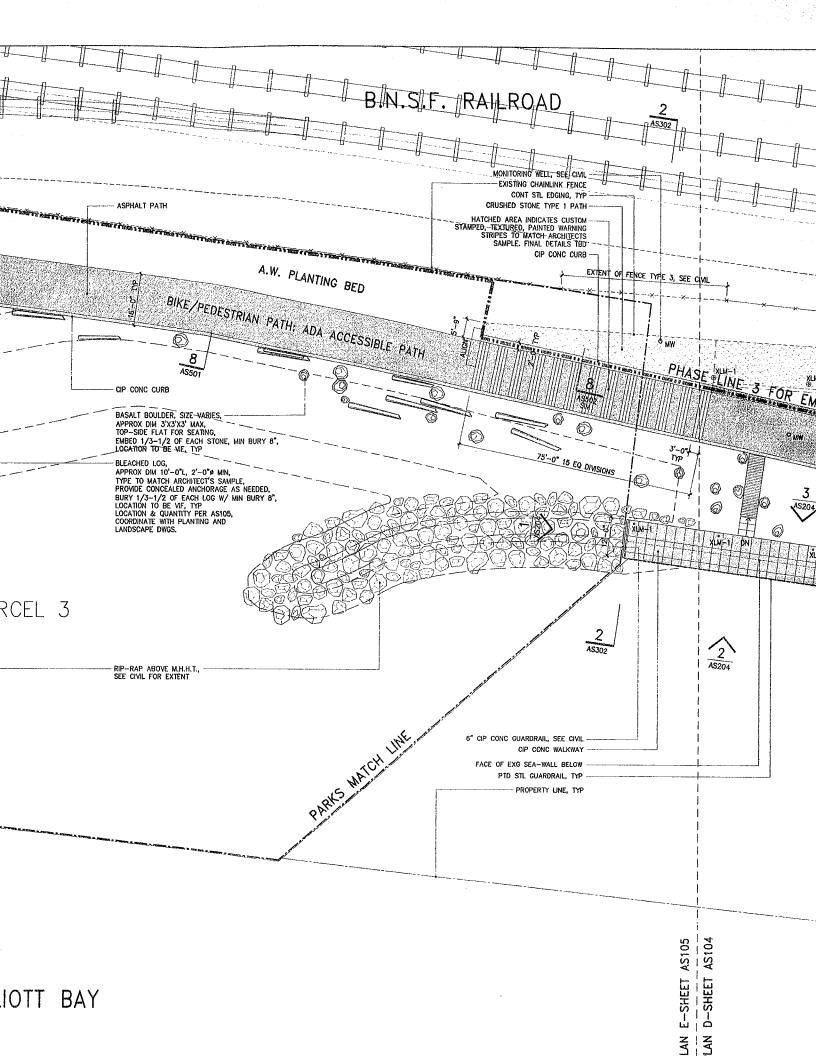
SITE PLAN D


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Seattle Art Museum Seattle, Washington 100 University Street Scattle, WA 98101

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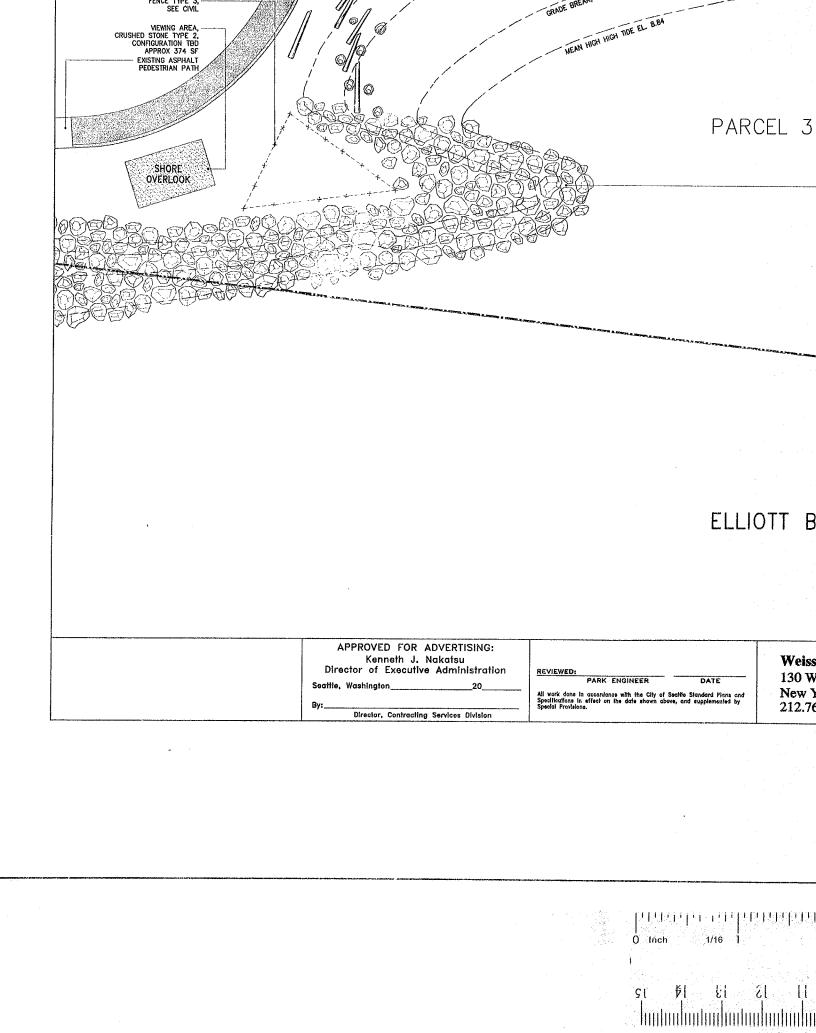
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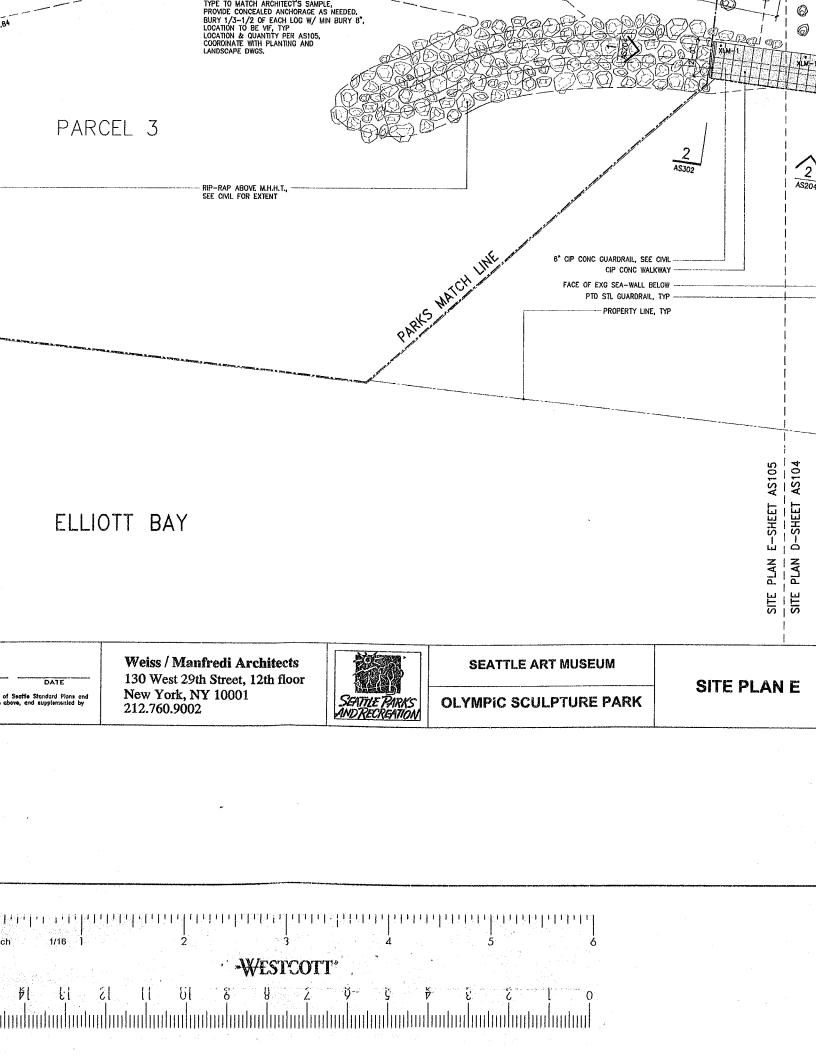
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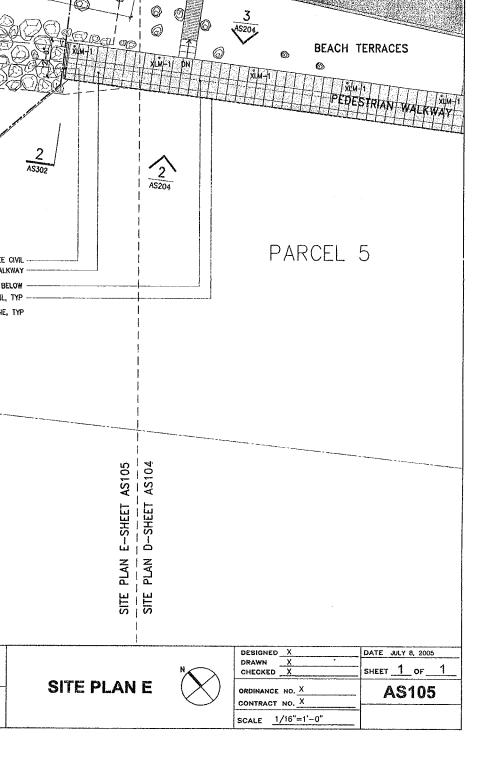
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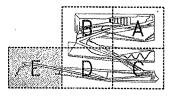
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CRUSHED STONE BASE STRIP
CONCRETE PAYING
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PROPERTY LINE

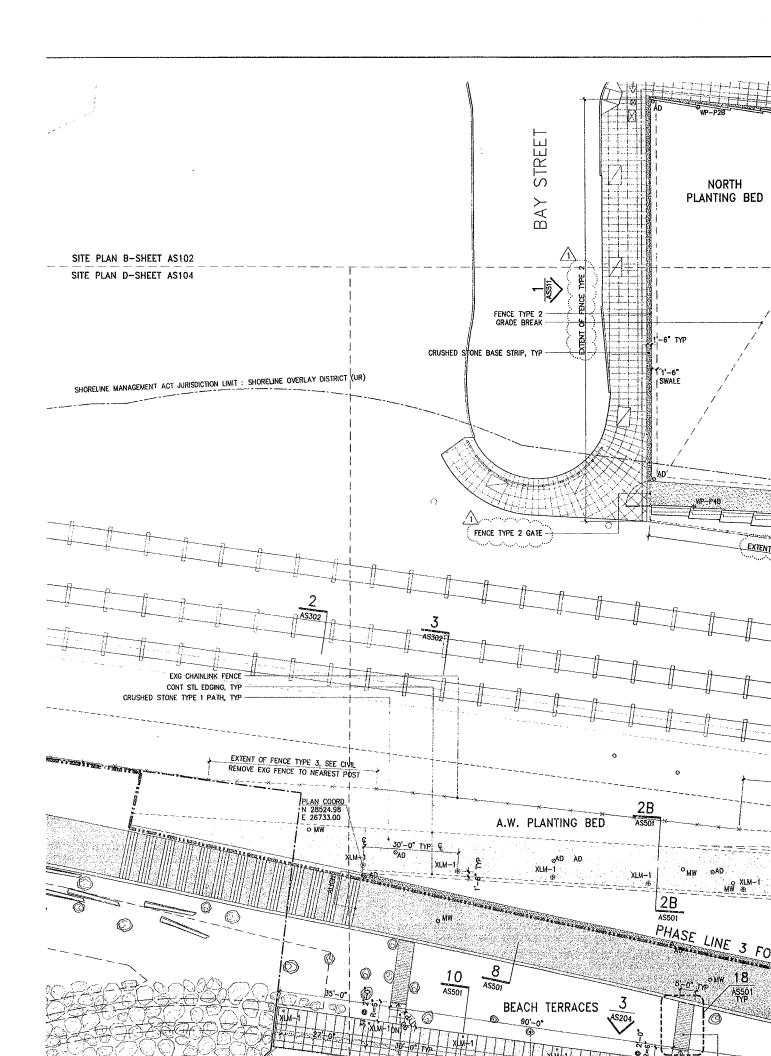

DRAWING TITLE

SITE PLAN E

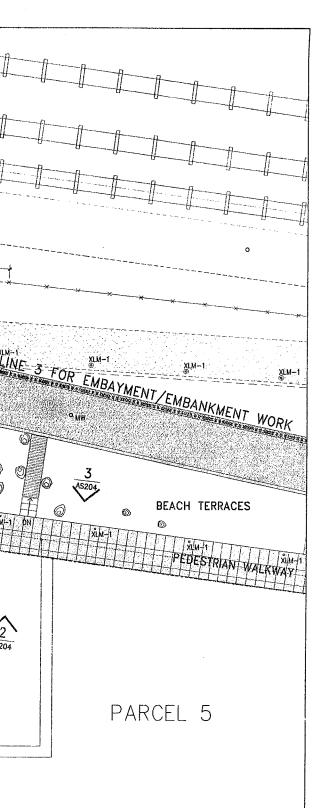
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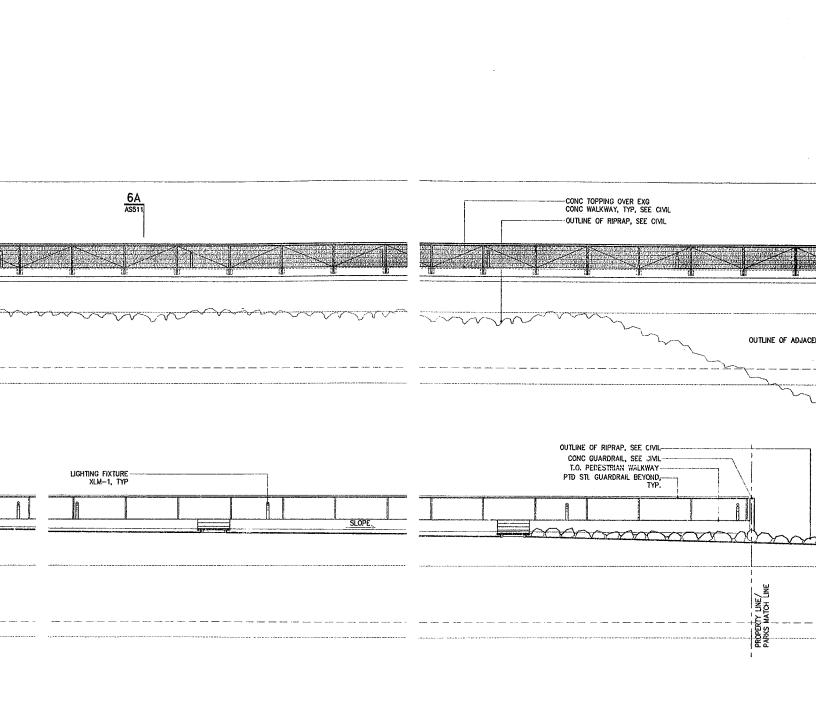
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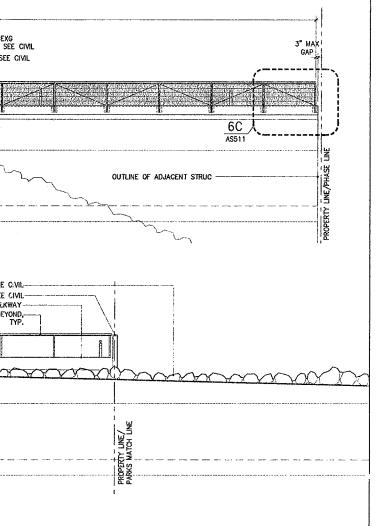
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AS105







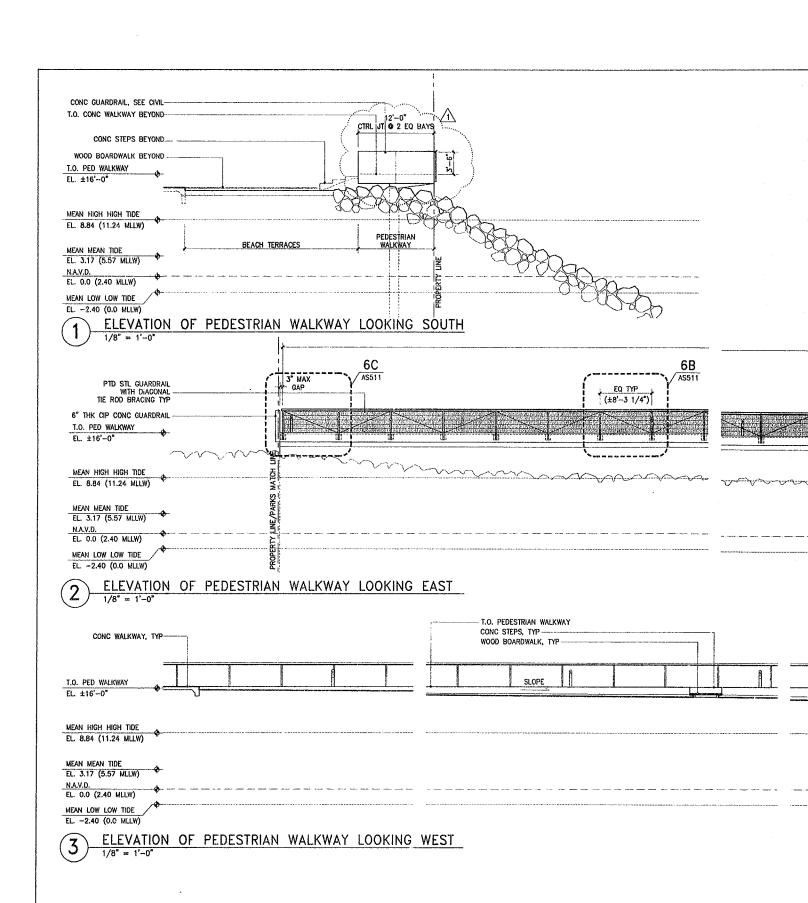

Seattle Art Museum Seattle, Washington 100 University Street Seattle, WA 98101

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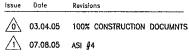
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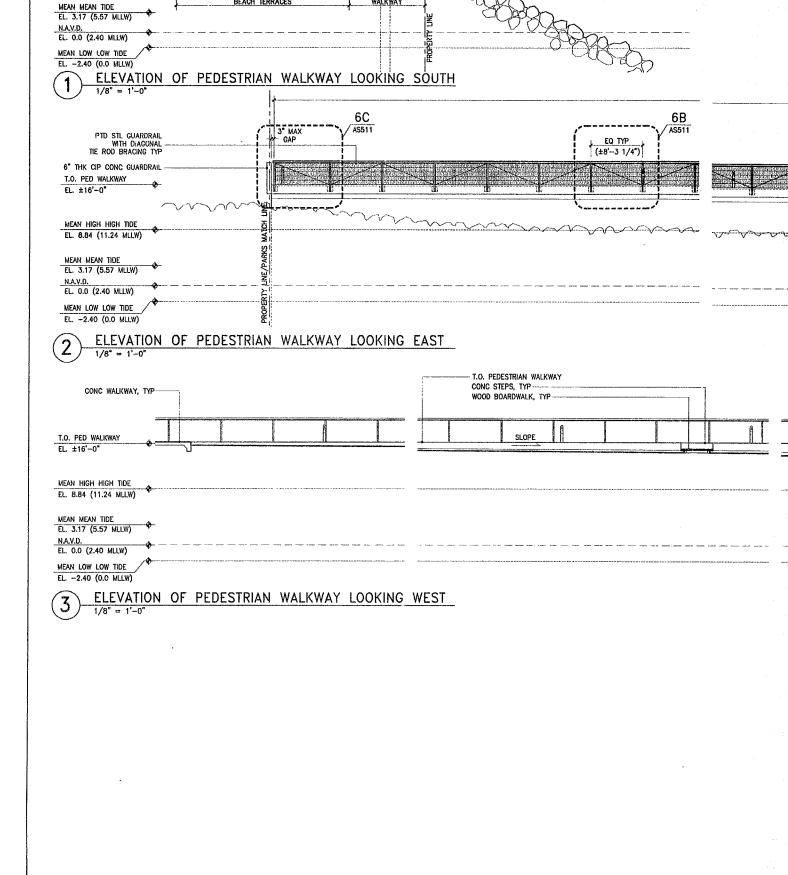
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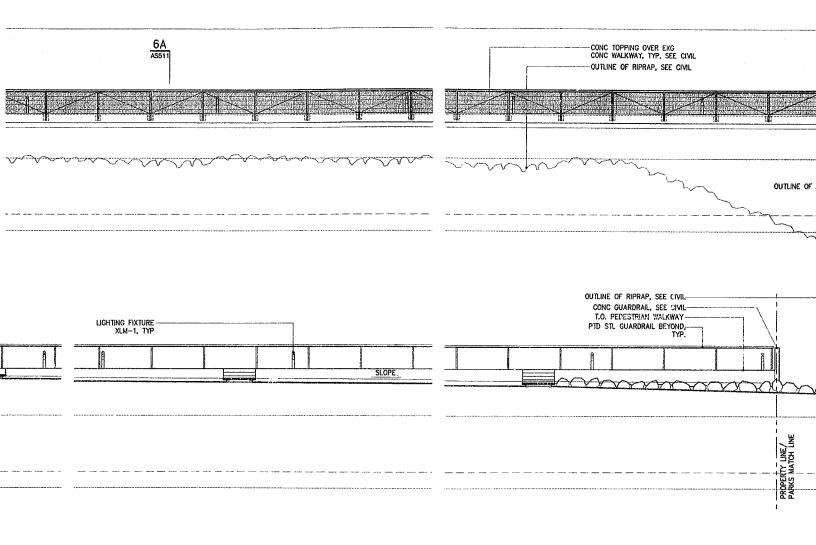
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APPROVED FOR ADVERTISING: Kenneth J. Nakatsu	
Director of Executive Administration	REVIEWED:
Seattle, Washington 20	PARK ENGINEER DATE
3y:	All work done in accordance with the City of Seattle Standard Plans and Specifications in effect on the date shown above, and supplemented by Special Provisions.
Director, Cantracting Services Division	

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SEATTLE ART MUSEUM

OLYMPIC SCULPTURE PARK

SITE ELEVATIONS EMBAYMENT/EMBANKMENT 0

C

6C AS511 LINE/PHASE OUTLINE OF ADJACENT STRUC OF RIPRAP, SEE C'VIL-GUARDRAIL, SEE CIVIL EDESTRIAN WALKWAY L GUARDRAIL BEYOND, TYP. PROPERTY LINE/ PARKS MATCH LINE

SITE ELEVATIONS
BAYMENT/EMBANKMENT

SCALE A	S NOTED		7	
ORDINANCE NO. X			AS204	
CHECKED	X		SHEET 1 OF 1	
DESIGNED DRAWN	^	<u> </u>	DATE JULY 8, 2005	

Lighting Consultant Brandston Partnership, Inc. 122 West 26th Street New York, NY 10001 212.924.4050

AV/IT/Security Consultant ARUP 155 Avenue of the Americas New York, NY 10013 212,229,2669


Food Service Consultant JLR Design Group, Inc. 557 Roy Street, Suite 175-A Seattle, WA 98109 206.625.0070

Construction Management Sellen Construction 227 Westlake Ave. N. Seattle, WA 98109 206.682.7770

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REGISTERED SUB-HITEEP
KEYS



DRAWING TITLE

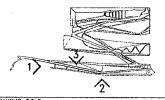
SITE ELEVATIONS


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 -- Date JULY 8, 2005


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 - Scole 1/8" = 1'-0"

 Drawing No.
 No.

AS204

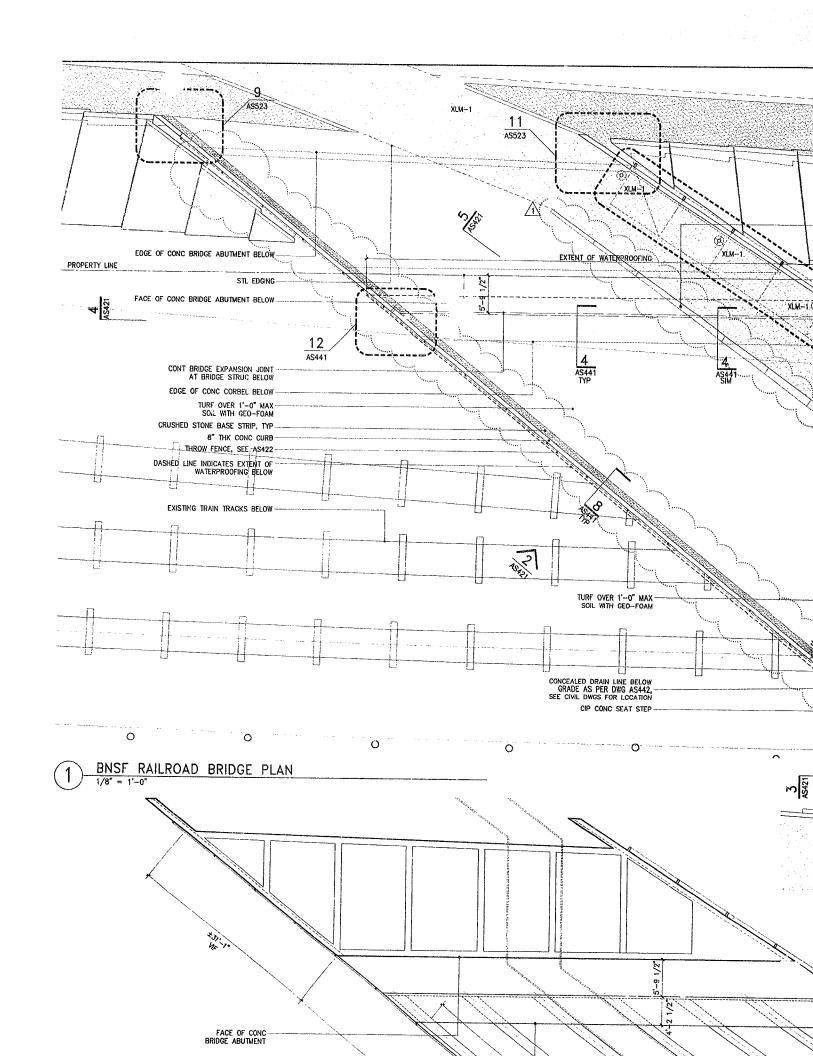


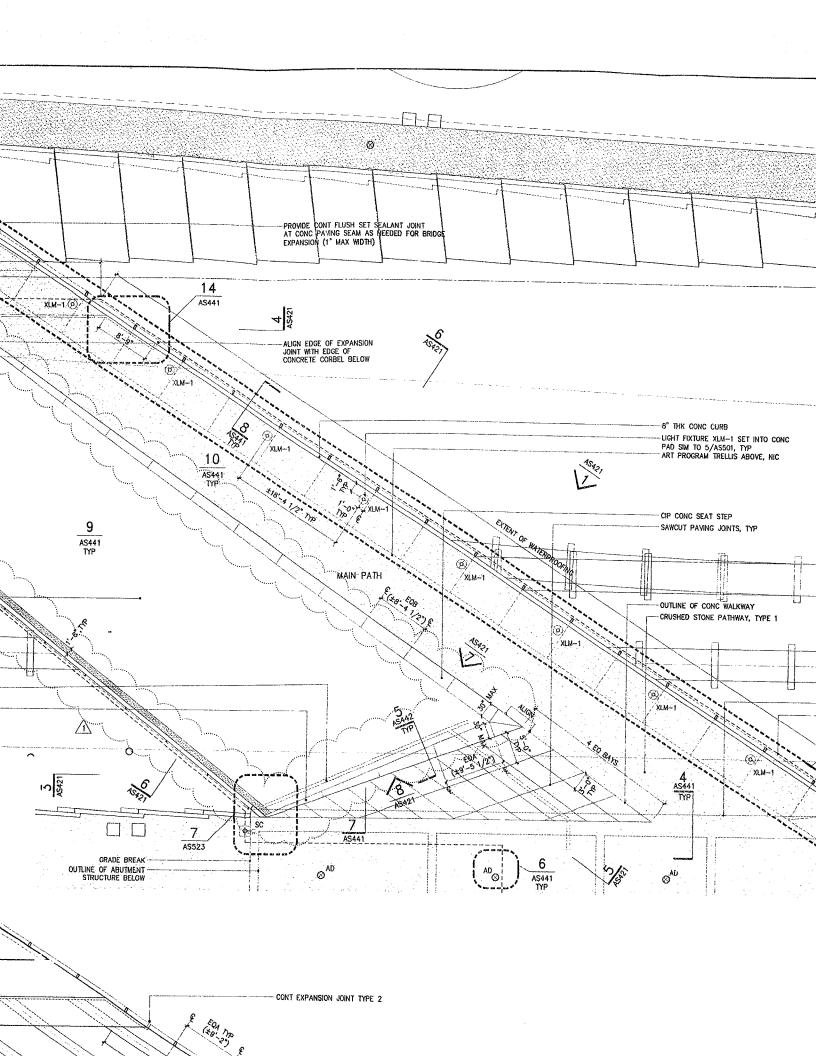

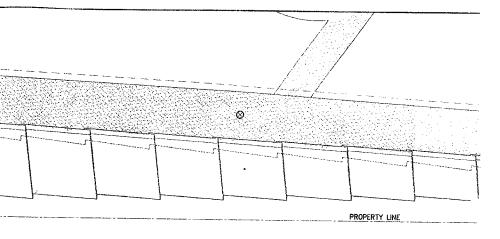

'THK CONC CURB GHT FIXTURE XLM-1 SET INTO CONC AD SIM TO 5/AS501, TYP RT PROGRAM TRELLIS ABOVE, NIC

P CONC SEAT STEP WCUT PAVING JOINTS, TYP

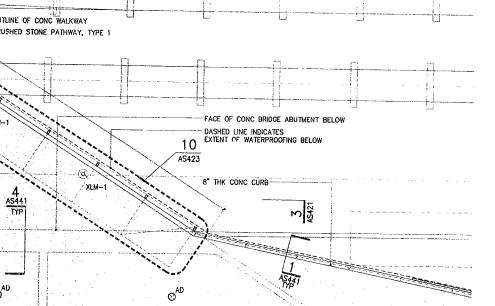

GENERAL NOTES:

1. ALL EXPOSED FRAMING, DECK CONDUIT AND FIXTURES TO BE FINISHED TO MATCH ARCHITECTS SAMPLE.

- 2. AT ELLIOTT BRIDGE ALL EXPOSED BEAM FLANGES TO BE PROVIDED WITH BIRD PROTECTION AS PER 11/AS442. ALL GAPS BETWEEN BEAMS AT GRADE BEAM TO BE PROVIDED WITH CONTINUOUS FULLY SEALED VERTICAL BIRD PROTECTION SCREEN.
- SEE DRAWING AS441 FOR TYPICAL WATERPROOFING DETAILS, PROVIDE CONTINUOUS FULLY SEALED WATER PROOFING ABOVE ALL BRIDGE STRUCTURE.
- 4 SEE DWG AS442 FOR TYPICAL LIGHTING DETAILS. ALL CONDUIT TO BE TIGHT TO UNDERSIDE OF DECK. FINAL LOCATION OF ALL EXPOSED FIXTURES AND CONDUIT TO BE VERIFIED BY ARCHITECT PRIOR TO INSTALLATION.

5. ALL PLANTING SOIL OVER BRIDGE STRUCTURE TO BE 12" MAX. PLACE

Olympic Sculpture Park

Seattle Art Museum Seattle, Washington 100 University Street Seattle, WA 98101

LEAD DESIGNER Site Design / Architecture Welss / Manfredi Architects 130 West 29th Street, 12th floor New York, NY 10001 212.760.9002

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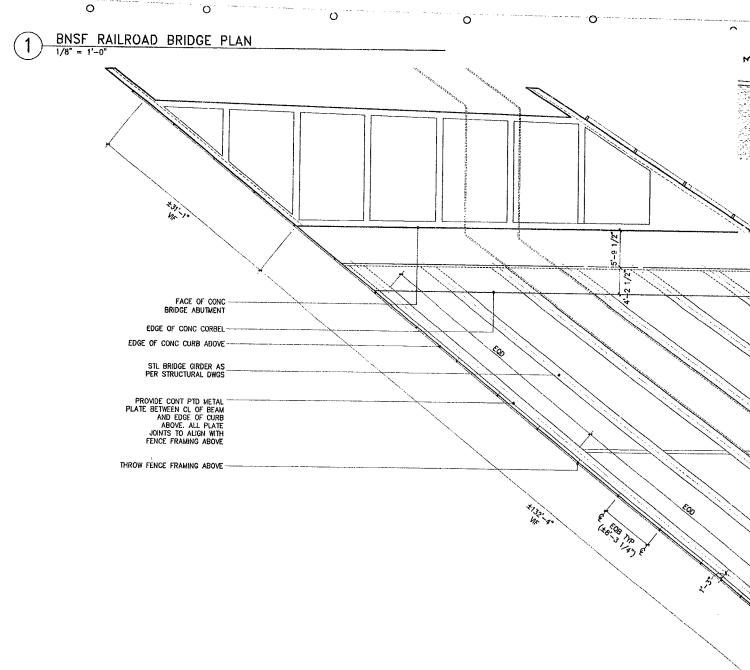
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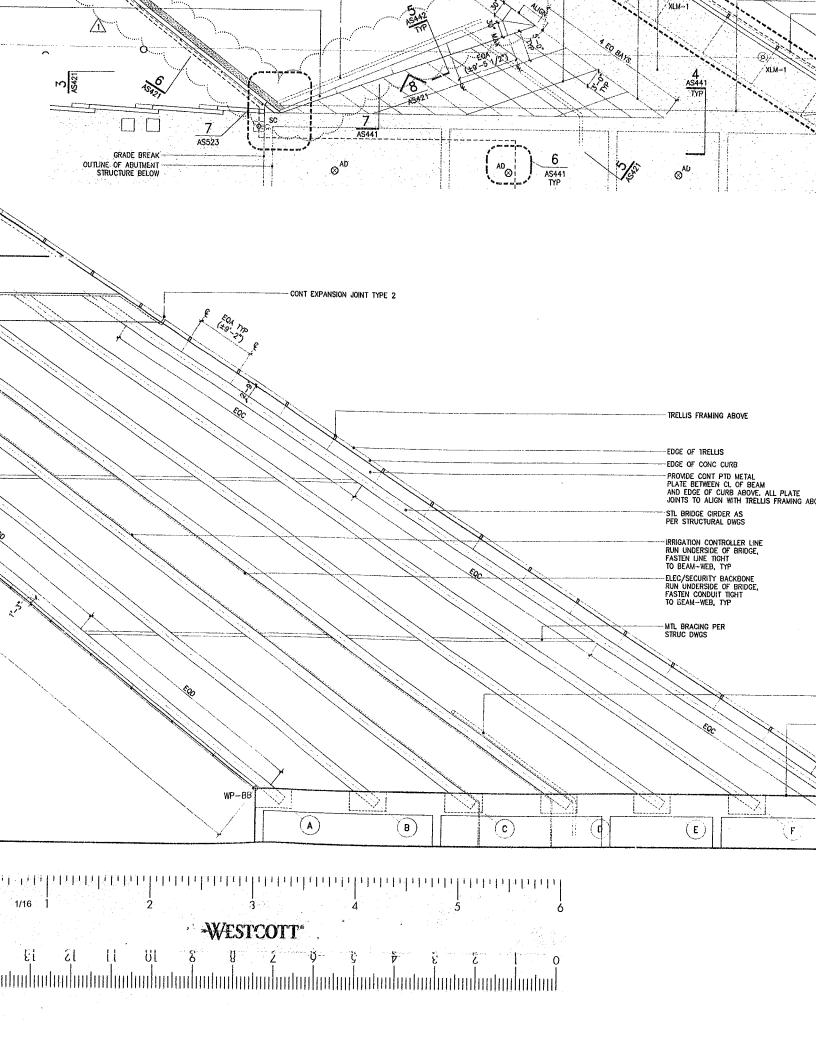
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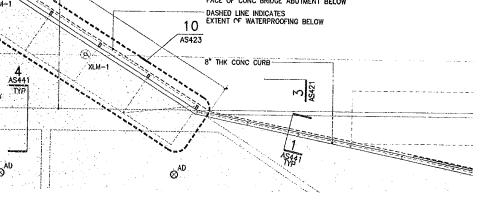
DRAWING HAS BEEN CLARIFIED W/ NO SCOPE CHANGE, UNLESS OTHERWISE NOTED BY REVISION CLOUD





2) BNSF RAILROAD BRIDGE RCP





GENERAL NOTES:

1. ALL EXPOSED FRAMING, DECK CONDUIT AND FIXTURES TO BE FINISHED TO MATCH ARCHITECTS SAMPLE.

- 2. AT ELLIOTT BRIDGE ALL EXPOSED BEAM FLANGES TO BE PROVIDED WITH BIRD PROTECTION AS PER 11/AS442. ALL GAPS BETWEEN BEAMS AT GRADE BEAM TO BE PROVIDED WITH CONTINUOUS FULLY SEALED VERTICAL BIRD PROTECTION SCREEN.
- 3. SEE DRAWING AS441 FOR TYPICAL WATERPROOFING DETAILS. PROVIDE CONTINUOUS FULLY SEALED WATER PROOFING ABOVE ALL BRIDGE STRUCTURE.
- 4 SEE DWG AS442 FOR TYPICAL LIGHTING DETAILS. ALL CONDUIT TO BE TIGHT TO UNDERSIDE OF DECK. FINAL LOCATION OF ALL EXPOSED FIXTURES AND CONDUIT TO BE VERIFIED BY ARCHITECT PRIOR TO INSTALLATION.
- 5. ALL PLANTING SOIL OVER BRIDGE STRUCTURE TO BE 12" MAX. PLACE GEO-FOAM TO MATCH GRADING REQUIREMENTS.
- 6. ALL STRUCTURAL MEMBERS & METAL DECKING TO BE PRIMED / GALVANIZED & PAINTED AS PER SPECIFICATIONS.
- 7. FOR PTD STL GUARDRAIL DETAILS, SEE AS511.
- 8. SEE LANDSCAPE FOR ALL TOP SOIL & PLANTING INFO.

LLIS FRAMING ABOVE

BRIDGE GIRDER AS STRUCTURAL DWGS

GATION CONTROLLER LINE UNDERSIDE OF BRIDGE, JEN LINE TIGHT JEAM-WEB, TYP

C/SECURITY BACKBONE UNDERSIDE OF BRIDGE, IEN CONDUIT TIGHT DEAM-WEB, TYP

BRACING PER

(E)

IVIDE CONT PTD METAL
TE BETWEEN CL OF BEAM
I EDGE OF CURB ABOVE. ALL PLATE
ITS TO ALIGN WITH TRELLIS FRAMING ABOVE

E OF TRELLIS E OF CONC CURB

- 10. FOR ALL DIMENSIONS / REINFORCING & T.O. ELEVATION OF CIP CONCRETE, SEE CIVIL & STRUCTURAL.
- 11. FOR STL EDGING PATHWAY STAKES, CUT DOWN TO ALLOW 2" CLEAR OVER ALL WATERPROOFING MATERIALS ON BRIDGE STRUCTURE.
- 13. SEE DWG AS501 FOR TYPICAL CONCRETE JOINT DETAILS. ALL EXPOSED CONCRETE JOINT TYPES AND LOCATIONS TO BE VERIFIED WITH ARCHITECT PRIOR TO INSTALLATION.

- 9. FOR ALL STREET SIDEWALK INFO, SEE CIVIL.

- 12. COORDINATE LOCATIONS OF ELEC/SEC FIXTURE INSTALLATION $\mbox{W/WATERPROOFING.}$
- 14. SEE DWG AS521-AS522 FOR TYPICAL PRECAST WALL GUARDRAIL DETAILS.

DRAIN LINE CONNECTION FROM ABOVE SLAB AS PER DWG AS442, RUN UNDERSIDE OF BRIDGE, FASTEN CONDUIT TIGHT TO BEAM-WEB, TYP, SEE CIVIL DWGS FOR LOCATION

FACE OF CONC BRIDGE ABUTMENT

WP-BB

(G

New York, NY 10013 212.229.2669

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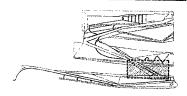
LEGEND

	CRUSHED STONE PATH TYPE 1
	CRUSHED STONE PATH TYPE 2
	FIBAR PATH
	CRUSHED STONE BASE STRIP
	CONCRETE PAVING
	ASPHALT
	GRADE BREAK
	STEEL EDGING
*****	DILLOW LAW WOLLD

PHASE MATCHLINE PARKS MATCHLINE ART PROGRAM, N.I.C.

PROPERTY LINE

KEY




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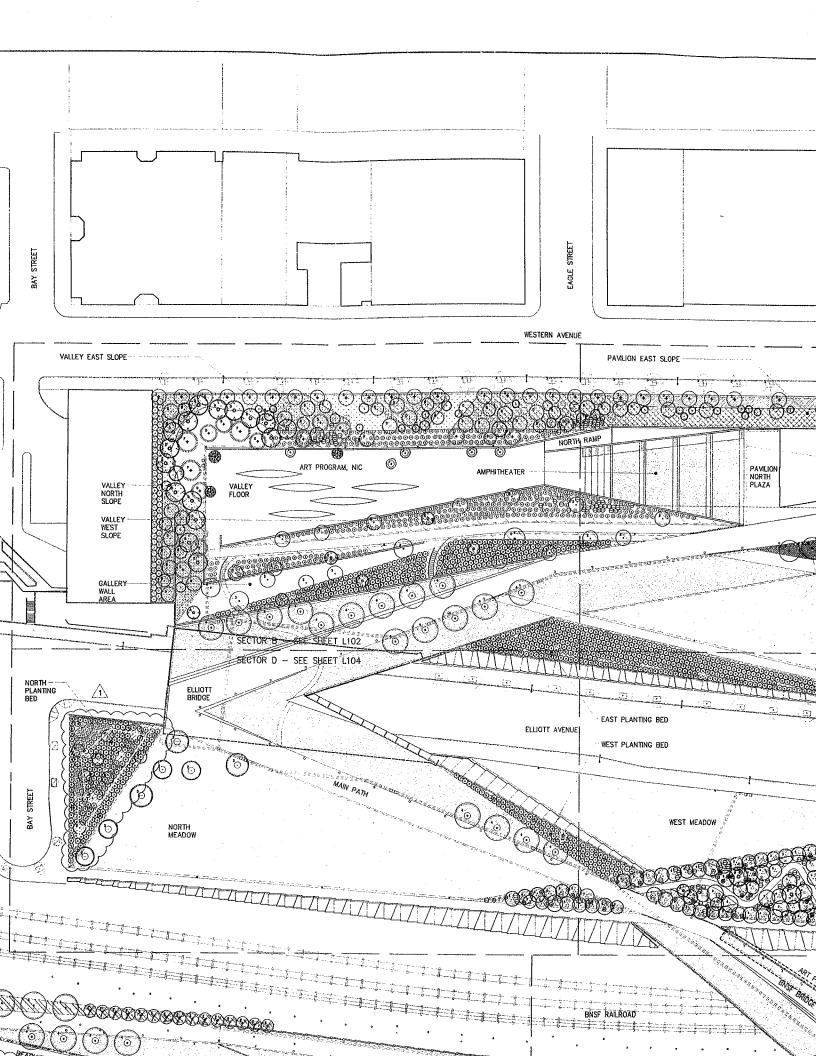
B.N.S.F. RAILROAD BRIDGE PLAN & RCP


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100% CD CONFORMANCE SET





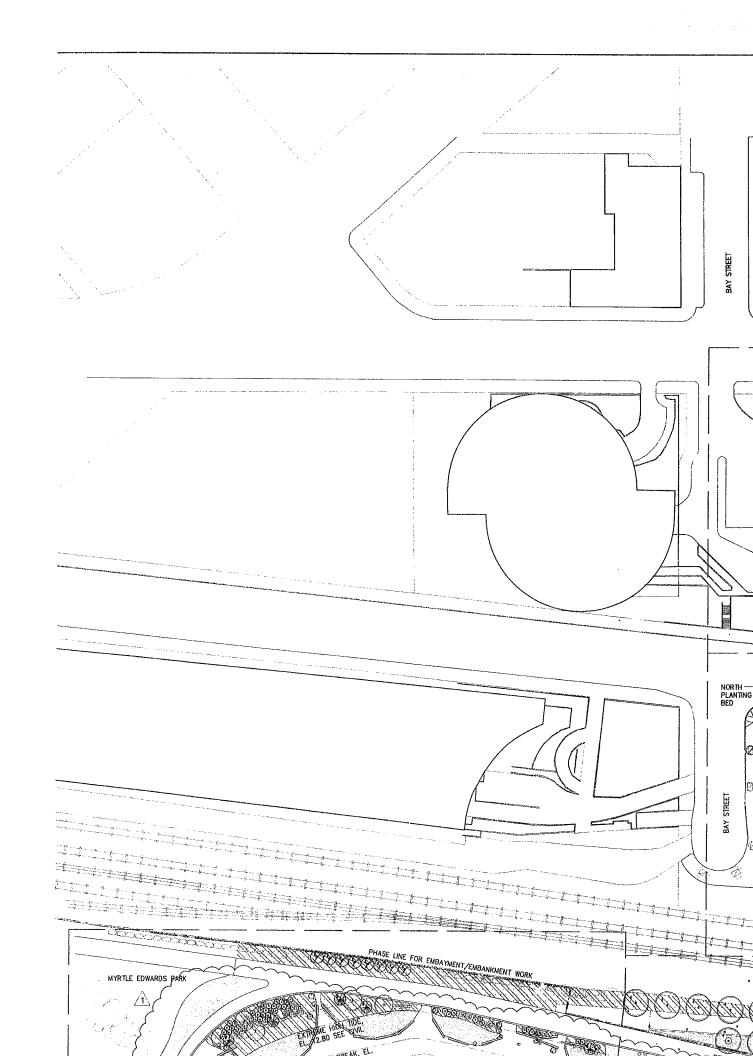

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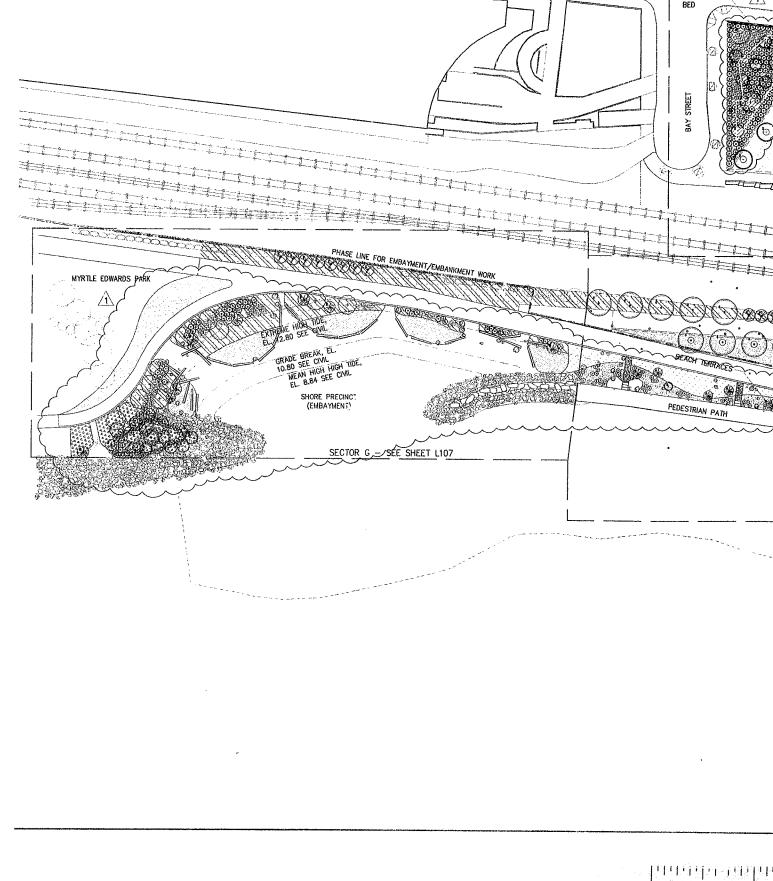
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0 03.04.05 100% CONSTRUCTION DOCUMENTS

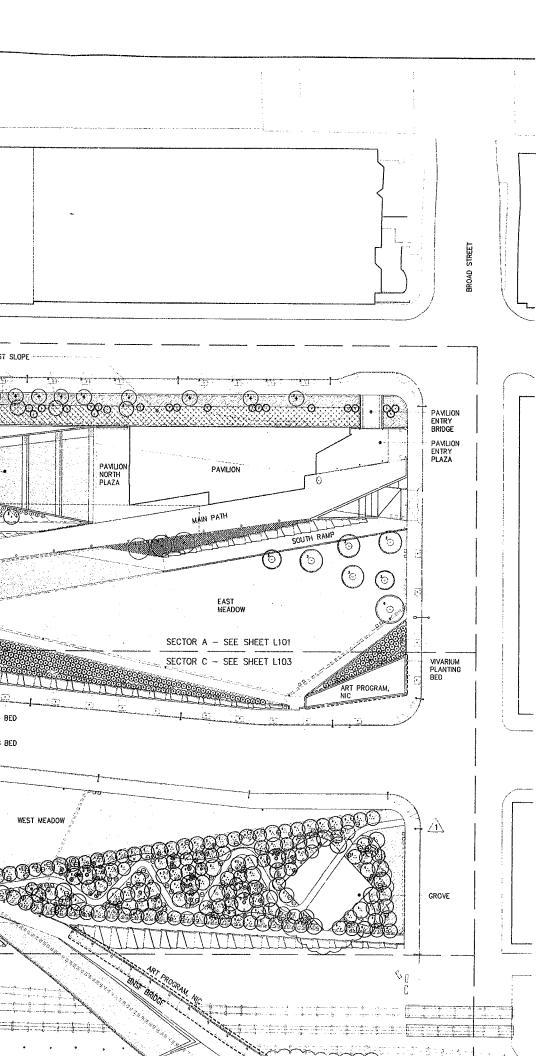
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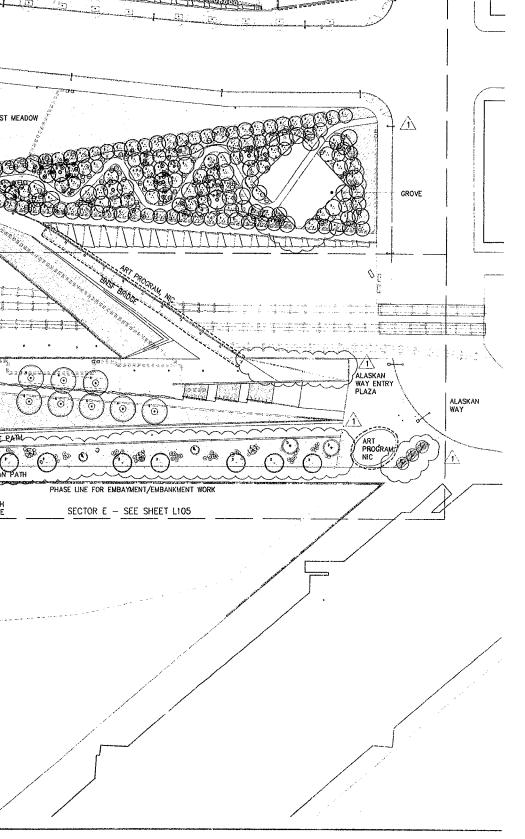
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PLANTING PLAN KEY PLAN

2cawa SM/JP Date JULY 8, 2005 Checked **CA** Scole 1" = 40'

Drawing No.




SECTOR E PLANT 'EGEND

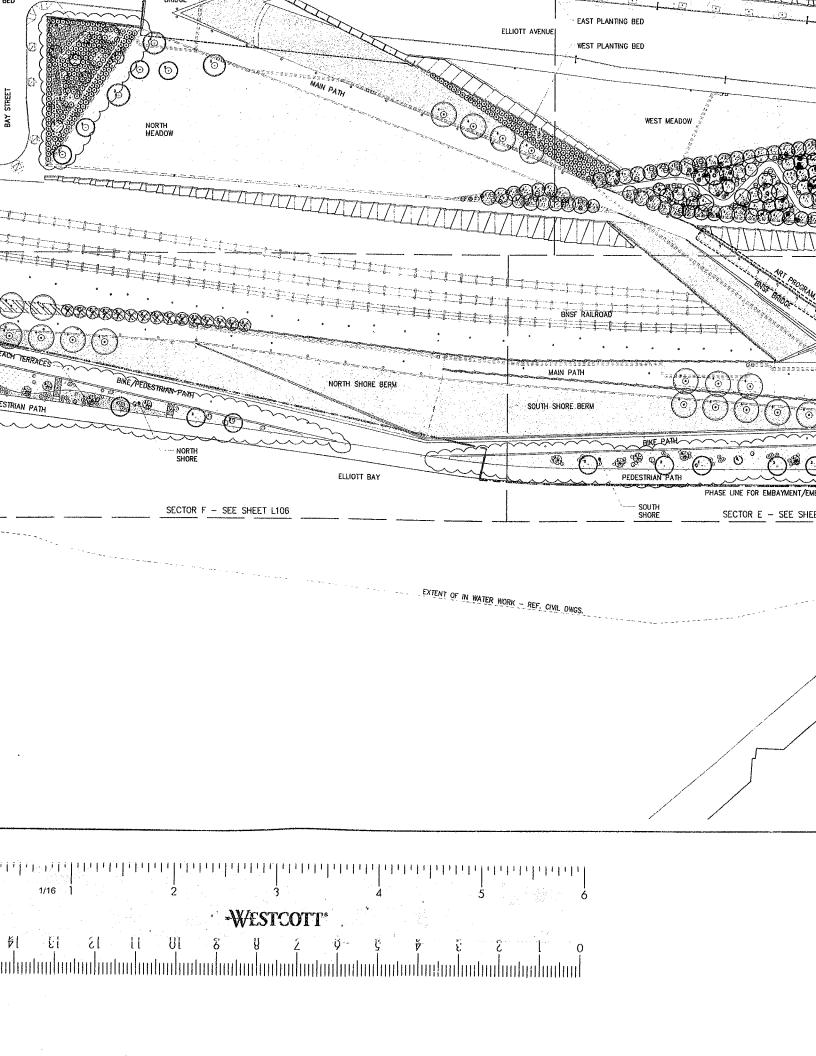
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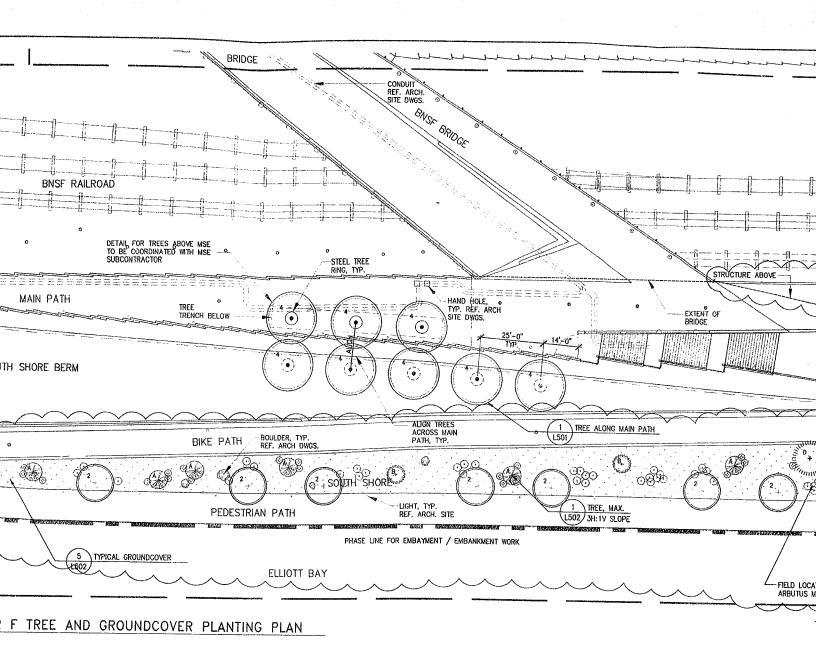
SYMBOL	BOTANICAL NAME	COMMON NAME	SIZE	SPACING	COMMENTS
(B.)	PICEA SITCHENSIS	SITKA SPRUCE	6-8' HT.	AS SHOWN	
NOT SHOWN	ARBUTUS MENZIESII	MADRONE	1 GAL.	FIELD LOCATE	
	PINUS CONTORTA CONTORTA	SHORE PINE	4-6' HT.	AS SHOWN	
2	QUERCUS GARRYANA	GARRY OAK	2" CAL.	AS SHOWN	
THOUSE THE THE THE THE THE THE THE THE THE TH	THUJA PLICATA	WESTERN RED CEDAR	10-12' HT.	AS SHOWN	
	ULMUS 'ACCODLADE'	ACCOLADE ELM	4" CAL.	AS SHOWN	
SHRUBS					
SYMBOL	BOTANICAL NAME	COMMON NAME	SIZE	SPACING	COMMENTS
©	ARCTOSTAPHYLOS COLUMBIANA	HAIRY MANZANITA	5 GAL.	AS SHOWN	
PLANT MIXES					
SYMBOL	BOTANICAL NAME	COMMON NAME	SIZE	SPACING	COMMENTS
	DESCAMPSIA CAESPITOSA	TUFTED HAIRGRASS	PLUG	36" O.C.	
	ELYMUS GLAUCUS	BLUE WILD RYE	PLUG	24" O.C.	
	FRAGARIA CHILOENSIS	BEACH STRAWBERRY	4" POTS	24" O.C.	
	FESTUCA IDAHOENSIS	IDAHO FESCUE	PLUG	48" O.C.	
	FRAGARIA CHILOENSIS	BEACH STRAWBERRY	4" POTS	8" O.C.	
TURF		**			
SYMBOL	COMMON NAME				COMMENTS
	SOD TURF GRASS				


PLANTING NOTES:


- 1. CONTRACTOR SHALL IRRIGATE ALL PROPOSED AND EXISTING PLANT MATERIAL FOR THE DURATION OF THE PROJECT.
- 2. CONTRACTOR IS REQUIRED TO VERIFY UTILITY LOCATIONS PRIOR TO CONSTRUCTION. CONTRACTOR SHALL CALL THE UTILITIES UNDERGROUND LOCATION CENTER (800-424-5555) AT LEAST TWO DAYS PRIOR TO CONSTRUCTION.
- 3. PLANT MATERIALS SHALL MEET STANDARDS SET FORTH IN THE LATEST EDITION OF THE AMERICAN STANDARD FOR NURSERY STOCK (ANSI-Z60.1) AND WASHINGTON STATE STANDARDS FOR NURSERY STOCK, ORDER NO. 1627. ALL PLANT MATERIAL SHALL HAVE SUFFICIENT ROOT DEVELOPMENT TO ASSURE SURVIVAL AND HEALTHY GROWTH. CONTAINER GROWN PLANT MATERIALS ARE REQUIRED TO HAVE SUFFICIENT ROOT GROWTH TO HOLD THE SOIL INTACT WHEN REMOVED FROM THE CONTAINER, BUT SHALL NOT BE ROOT BOUND.
- 4. ALL TREES SHALL HAVE HEALTHY AND STRONG CENTRAL LEADERS TO ENSURE OPTIMUM GROWTH AND SURVIVAL.



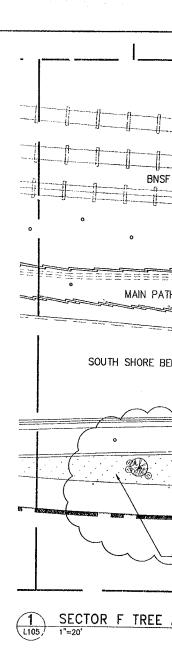

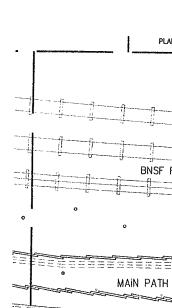

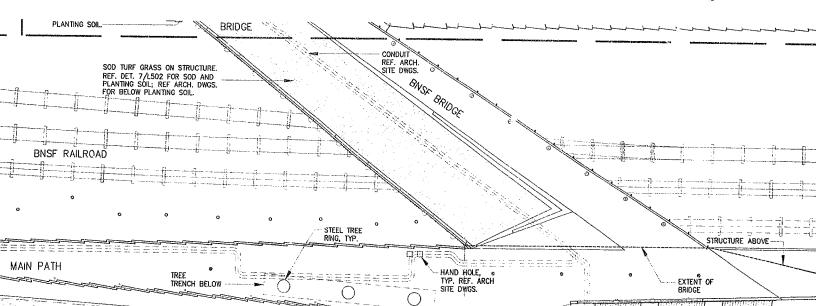

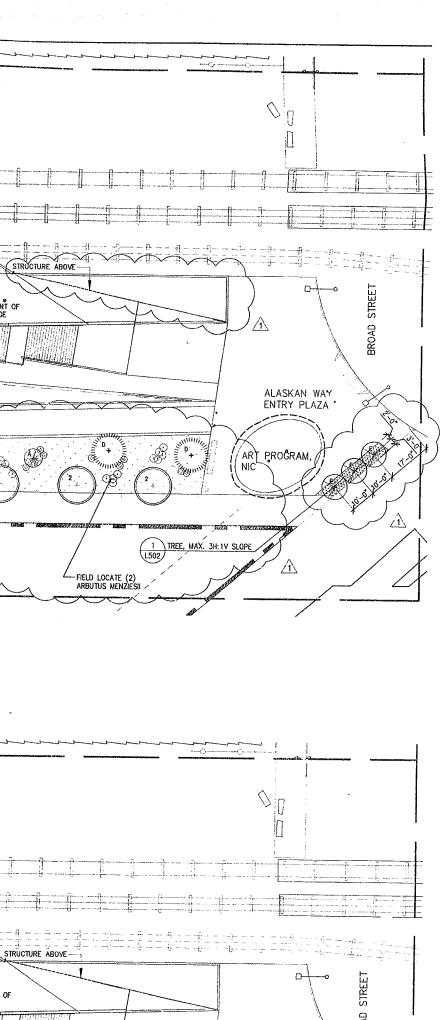

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issue Date


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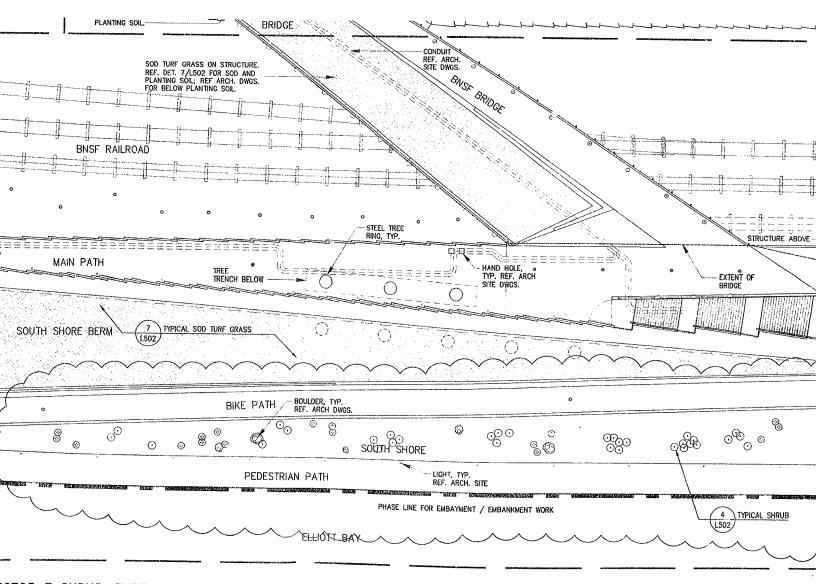
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PLANTING NOTES:


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- 4. ALL TREES SHALL HAVE HEALTHY AND STRONG CENTRAL LEADERS TO ENSURE OPTIMUM GROWTH AND SURVIVAL.
- 5. ALIGN ROWS OF TREES, SHRUBS AND GROUNDCOVER TO ADJACENT WALLS, PATHS, AND GRADE BREAKS UNLESS OTHERWISE NOTED.
- 6. ALL DIMENSIONS ARE TO CENTER OF TREE UNLESS OTHERWISE NOTED.
- 7. REFER TO TYPICAL PLANTING DETAILS FOR SHRUBS, GROUNDCOVER, SOD TURF GRASS, MEADOW GRASS AND PLUGS ON SHEET L502 UNLESS OTHERWISE NOTED.
- 8. REFER TO SHEET L301 FOR MASTER PLANT SCHEDULE AND FIELD LOCATED PLANTS.
- 9. REFER TO SHEET L401 FOR TYPE AND DEPTH OF PLANTING SOIL MIXES.
- 10. MULCH SHALL BE INSTALLED TO A DEPTH OF 3-INCHES IN ALL PLANTING BEDS EXCEPT INSTALL NO MULCH AT SHORE PRECINCT BEACH.
- 11. INSTALL TEMPORARY PROTECTION BARRIER ALONG PERIMETER OF ALL MEADOW AREAS TO PREVENT ACCESS AND DISTURBANCE TO MEADOW AREAS. BARRIER SHALL REMAIN IN PLACE UNTIL GRASS IS WELL ESTABLISHED AND EXHIBITS A VIGOROUS GROWING CONDITION AS APPROVED BY LANDSCAPE ARCHITECT. REFER TO SECTION 0.2930.
- 12. INSTALL TEMPORARY PROTECTION BARRIER ALONG PERIMETER OF ALL PLANTING AREAS AT SHORE PRECINCT AS SHOWN TO PREVENT ACCESS AND DISTURBANCE TO PLANTING AREAS. BARRIER SHALL REMAIN IN PLACE UNTIL PLANTS ARE WELL ESTABLISHED OR UNTIL REMOVAL IS APPROVED BY OWNER. REFER TO SECTION 02930 2.6 & 3.8.
- 13. INSTALL ROOT BARRIER ALONG PERIMETER OF GROVE AREAS AS SHOWN. SET ROOT BARRIER 2-INCHES BELOW FINISH GRADE. ROOT BARRIERS SET PRIOR TO CONSTRUCTION MAY REQUIRE ADJUSTMENT LATER TO ENSURE FINAL LOCATION IS 2-INCHES BELOW FINISH GRADE. REFER TO SECTION 02950.
- 14. REFER TO CIVIL DWGS. FOR LAYOUT, QUANTITIES, SPECIES AND PLANTING DETAIL FOR STREET TREES.
- 15. REFER TO CIVIL/ARCH. SITE DWGS. FOR LAYOUT OF SITE WALLS & HARDSCAPE ELEMENTS AND FOR GRADING.
- 16. REFER TO CIVIL FOR LIMITS OF TREE PROTECTION, REFER TO SHT. L502 FOR TREE PROTECTION DETAIL.
- 17. NO PESTICIDES, HERBICIDES OR CHEMICAL FERTILIZERS SHOULD BE APPLIED TO VEGETATION AT THE SHORE PRECINCT.




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CTOR F SHRUB, TURF AND MEADOW PLANTING PLAN



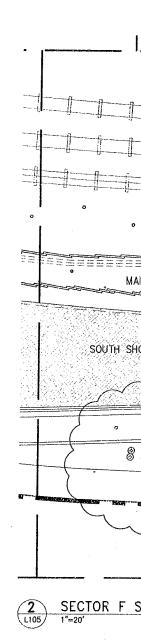
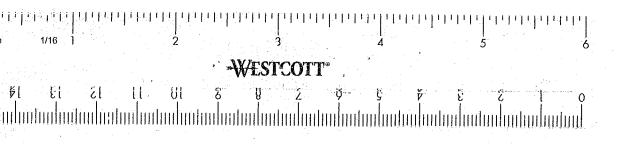
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Date Revisions 03.04.05 100% CONSTRUCTION DOCUMENTS

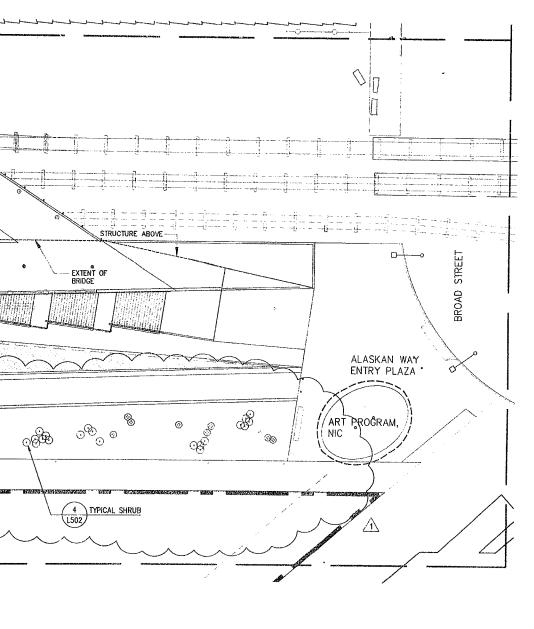07.08.05 ASI #4

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DRAWING TITLE

PLANTING PLAN SECTOR E

Drawn SM/JP Date JULY 8, 2005 Checked CA

Scole 1" = 20'


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REES SYMBOL	BOTANICAL NAME	COMMON NAME	9175	001000
	BO Francisco	COMMON NAME	SIZE	SPACING
E	CALOCEDRUS DECURRENS	INCENSE CEDAR	12' - 14' HT.	AS SHOW
(8,)	PICEA SITCHENSIS	SITKA SPRUCE	6-8' HT.	AS SHOW
	PINUS CONTORTA	SHORE PINE	4-6' HT.	AS SHOW
•	ULMUS 'ACCODLADE'	ACCOLADE ELM	4" CAL.	AS SHOW
	QUERCUS GARRYANA	GARRY OAK	2" CAL.	AS SHOW
NOT SHOWN	SALIX SCOULERIANA	SCOULER WILLOW	15 GAL.	FIELD LOCAT
NOT SHOWN	SALIX HOOKERIANA	HOOKER'S WILLOW	15 GAL.	FIELD LOCAT
IRUBS SYMBOL	BOTANICAL NAME	COMMON NAME	SIZE	SPACING
⊗	ARCTOSTAPHYLOS COLUMBIANA	HAIRY MANZANITA	5 GAL.	AS SHOW
0	VACCINIUM OVATUM	EVERGREEN HUCKLEBERRY	2 GAL.	AS SHOW
ANT MIXES	4			
SYMBOL	BOTANICAL NAME	COMMON NAME	SIZE	SPACING
<u> </u>				
	FRAGARIA CHILOENSIS	BEACH STRAWBERRY	4" POT	24" O.C.
	GAULTHERIA SHALLON	SALAL	1 GAL.	36" O.C.
	DESCAMPSIA CAESPITOSA	TUFTED HAIRGRASS	PLUG	36" O.C.
	ELYMUS GLAUCUS	BLUE WILD RYE	PLUG	24" O.C.
	FESTUCA IDAHOENSIS	IDAHO FESCUE	PLUG	48" O.C.
	FRAGARIA CHILOENSIS	BEACH STRAWBERRY	4" POT	24" O.C.
	FRAGARIA CHILOENSIS	BEACH STRAWBERRY	4" POT	24" O.C.
	GAULTHERIA SHALLON	SALAL	1 GAL.	36" O.C.
	SPIREA DOUGLASII	DOUGLAS SPIREA	1 GAL.	FIELD LOCATE
₹F				
SYMBOL	COMMON NAME			


PLANTING NOTES:



BEACH TERRACES

^{1.} CONTRACTOR SHALL IRRIGATE ALL PROPOSED AND EXISTING PLANT MATERIAL FOR THE DURATION OF THE PROJECT.

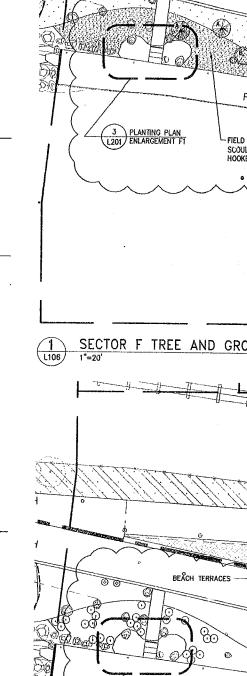^{2.} C/NTRACTOR IS REQUIRED TO VERIFY UTILITY LOCATIONS PRIOR TO CONSTRUCTION. CONTR.\CTOR SHALL CALL THE UTILITIES UNDERGROUND LOCATION CENTER (800-424-5555) AT LEAST TWO DAYS PRIOR TO CONSTRUCTION.

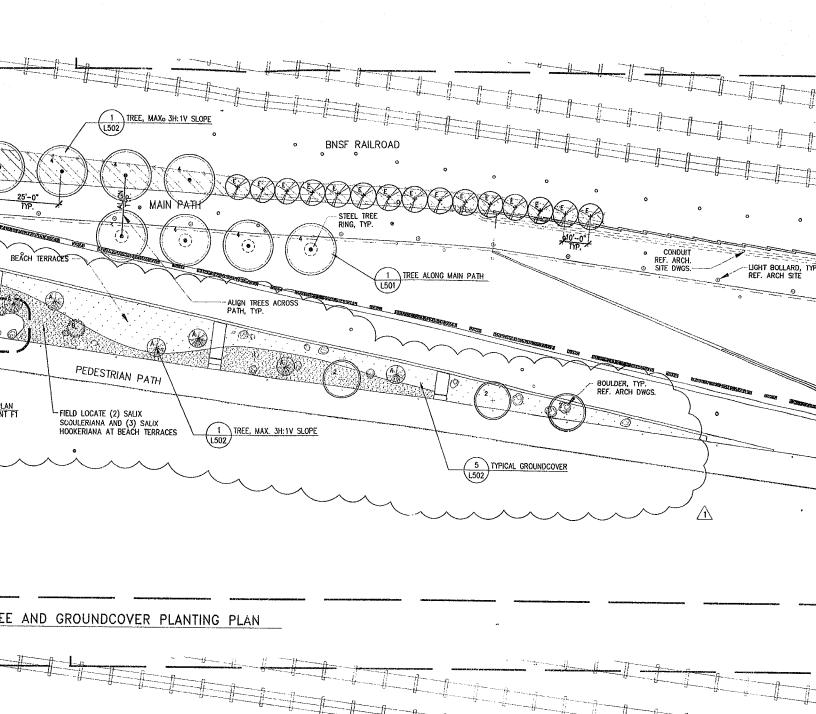

BRSF RAILROAD

MAIN PATH

BEÄCH TERRACES

ONDUIT
REF. ARCH. SITE
DIGS

TYPICAL
USGS

T

CONDUIT f. arch. E Dwgs. LIGHT BOLLARD, TYP. REF. ARCH SITE HAND HOLE, TYP. REF. ARCH SITE NORTH SHORE BERM \triangle **ELLIOTT BAY** NDUIT ARCH. DWGS. LIGHT BOLLARD, REF. ARCH SITE HAND HOLE, TYP. REF. ARCH SITE -7 TYPICAL SOD TURF GRASS

Olympic Sculpture Park

Seattle Art Museum Seattle, Washington 100 University Street Seattle, WA 98101

LEAD DESIGNER Site Design / Architecture
Weiss / Manfredi Architects
130 West 29th Street, 12th floor New York, NY 10001 212.760.9002

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Food Service Consultant JLR Design Group, Inc. 557 Roy Street, Suite 175-A Seattle, WA 98109 206.625.0070

Construction Management Sellen Construction 227 Westlake Ave. N. Seattle, WA 98109 206.682.7770

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Issue Date Revisions

03.04.05 100% CONSTRUCTION DOCUMENTS



1 07.08.05 ASI #4


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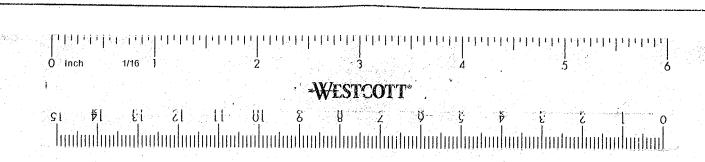
	DESCAMPSIA CAESPITOSA	TUFTED HAIRGRASS	PLUG	36" O.C.
	ELYMUS GLAUCUS	BLUE WILD RYE	PLUG	24" O.C.
	FESTUCA IDAHOENSIS	IDAHO FESCUE	PLUG	48" O.C.
	FRAGARIA CHILOENSIS	BEACH STRAWBERRY	4" POT	24" O.C.
2017.03	FRAGARIA CHILOENSIS	BEACH STRAWBERRY	4" POT	24" O.C.
	GAULTHERIA SHALLON	SALAL	1 GAL.	36" O.C.
	SPIREA DOUGLASH	DOUGLAS SPIREA	1 GAL.	FIELD LOCATE
TURF				
SYMBOL	COMMON NAME			
	SOD TURF GRASS			


PLANTING NOTES:


- 1. CONTRACTOR SHALL IRRIGATE ALL PROPOSED AND EXISTING PLANT MATERIAL FOR THE DURATION OF THE PROJECT.
- 2. CYNTRACTOR IS REQUIRED TO VERIFY UTILITY LOCATIONS PRIOR TO CONSTRUCTION. CONTRACTOR SHALL CALL THE UTILITIES UNDERGROUND LOCATION CENTER (800-424-5555) AT LEAST TWO DAYS PRIOR TO CONSTRUCTION.
- 3 PLANT MATERIALS SHALL MEET STANDARDS SET FORTH IN THE LATEST EDITION OF THE AMERICAN STANDARD FOR NURSERY STOCK (ANSI-Z60.1) AND WASHINGTON STATE STANDARDS FOR NURSERY STOCK, ORDER NO. 1627. ALL PLANT MATERIAL SHALL HAVE SUFFICIENT ROOT DEVELOPMENT TO ASSURE SURVIVAL AND HEALTHY GROWTH. CONTAINER GROWN PLANT MATERIALS ARE REQUIRED TO HAVE SUFFICIENT ROOT GROWTH TO HOLD THE SOIL INTACT WHEN REMOVED FROM THE CONTAINER, BUT SHALL NOT BE ROOT BOUND.
- 4. ALL TREES SHALL HAVE HEALTHY AND STRONG CENTRAL LEADERS TO ENSURE OPTIMUM GROWTH AND SURVIVAL.
- 5. ALIGN ROWS OF TREES, SHRUBS AND GROUNDCOVER TO ADJACENT WALLS, PATHS, AND GRADE BREAKS UNLESS OTHERWISE NOTED.
- 6. ALL DIMENSIONS ARE TO CENTER OF TREE UNLESS OTHERWISE NOTED.
- REFER TO TYPICAL PLANTING DETAILS FOR SHRUBS, GROUNDCOVER, SOD TURF GRASS, MEADOW GRASS AND PLUGS ON SHEET L502 UNLESS OTHERWISE NOTED.
- 8. REFER TO SHEET L301 FOR MASTER PLANT SCHEDULE AND FIELD LOCATED PLANTS.
- 9. REFER TO SHEET L401 FOR TYPE AND DEPTH OF PLANTING SOIL MIXES.
- 10. MULCH SHALL BE INSTALLED TO A DEPTH OF 3-INCHES IN ALL PLANTING BEDS EXCEPT INSTALL NO MULCH AT SHORE PRECINCT BEACH.
- 11. INSTALL TEMPORARY PROTECTION BARRIER ALONG PERIMETER OF ALL MEADOW AREAS TO PREVENT ACCESS AND DISTURBANCE TO MEADOW AREAS. BARRIER SHALL REMAIN IN PLACE UNTIL GRASS IS WELL ESTABLISHED AND EXHIBITS A VICOROUS GROWING CONDITION AS APPROVED BY LANDSCAPE ARCHITECT. REFER TO SECTION 02930.
- 12. INSTALL TEMPORARY PROTECTION BARRIER ALONG PERIMETER OF ALL PLANTING AREAS AT SHORE PRECINCT AS SHOWN TO PREVENT ACCESS AND DISTURBANCE TO PLANTING AREAS. BARRIER SHALL REMAIN IN PLACE UNTIL PLANTS ARE WELL ESTABLISHED OR UNTIL REMOVAL IS APPROVED BY OWNER. REFER TO SECTION 02930 2.6 & 3.8.
- 13. INSTALL ROOT BARRIER ALONG PERIMETER OF GROVE AREAS AS SHOWN. SET ROOT BARRIER 2-INCHES BELOW FINISH GRADE. ROOT BARRIERS SET PRIOR TO CONSTRUCTION MAY REQUIRE ADJUSTMENT LATER TO ENSURE FINAL LOCATION IS 2-INCHES BELOW FINISH GRADE. REFER TO SECTION 02950.
- 14. REFER TO CIVIL DWGS. FOR LAYOUT, QUANTITIES, SPECIES AND PLANTING DETAIL FOR STREET TREES.
- 15. REFER TO CIVIL/ARCH. SITE DWGS. FOR LAYOUT OF SITE WALLS & HARDSCAPE ELEMENTS AND FOR GRADING.
- 16. REFER TO CIVIL FOR LIMITS OF TREE PROTECTION. REFER TO SHT. L502 FOR TREE PROTECTION DETAIL.
- 17. NO PESTICIDES, HERBICIDES OR CHEMICAL FERTILIZERS SHOULD BE APPLIED TO VEGETATION AT THE SHORE PRECINCT.

2 L106



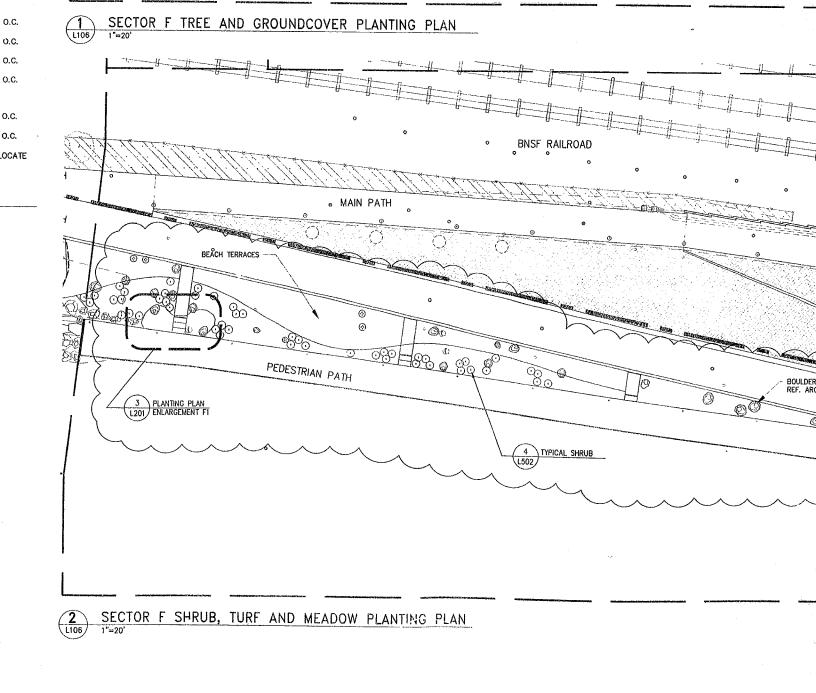

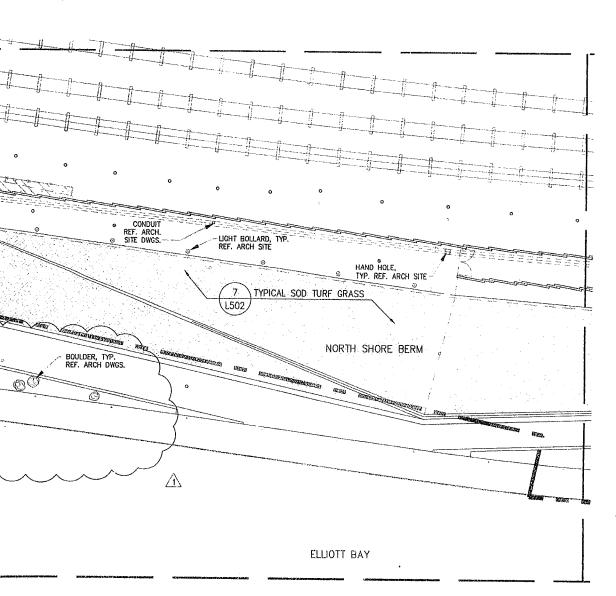

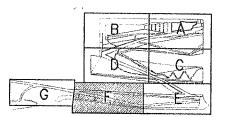

Food Service Consultant JI.R Design Group, Inc. 557 Roy Street, Suite 175-A Seattle, WA 98109 206.625.0070

Construction Management Sellen Construction 227 Westake Ave. N. Seattle, WA 98109 206.682,7770

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Date Revisions

0 03.04.05 100% CONSTRUCTION DOCUMENTS



1 07.08.05 ASI #4

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DRAWING TITLE

PLANTING PLAN SECTOR F

Drawn SM/JP Date JULY 8, 2005 Checked CA Scale 1" = 20'

Drawing No.

EES SYMBOL	BOTANICAL NAME	COMMON NAME	SIZE	SPACING
+	ALNUS RUBRA	RED ALDER	1-1/2" CAL.	AS SHOWN
E	CALOCEDRUS DECURRENS	INCENSE CEDAR	12' - 14' HT.	AS SHOWN
	PICEA SITCHENSIS	SITKA SPRUCE	6-8' HT.	AS SHOWN
	PINUS CONTORTA CONTORTA	SHORE PINE	4-6' HT.	AS SHOWN
8	PINUS CONTORTA CONTORTA	SHORE PINE	6-8' HT.	AS SHOWN
B.	PSEUDOTSUGA MENZIESII	DOUGLAS FIR	6~8' HT.	AS SHOWN
THE PARTY OF THE P	THUJA PLICATA	WESTERN RED CEDAR	10-12' HT.	AS SHOWN
	ULMUS 'ACCODLADE'	ACCOLADE ELM	4" CAL.	AS SHOWN
RUBS				
SYMBOL ②	ARCTOSTAPHYLOS COLUMBIANA	COMMON NAME	SIZE	SPACING
Θ		HAIRY MANZANITA	5 GAL.	AS SHOWN
	MAHONIA AQUIFOLIUM	OREGON GRAPE	2 GAL.	AS SHOWN
0	MAHONIA NERVOSA	DULL OREGON GRAPE	2 GAL.	AS SHOWN
θ.	ROSA NUTKANA	NOOTKA ROSE	2 GAL.	AS SHOWN
⊗	SYMPHORICARPOS ALBUS	SNOWBERRY	2 GAL	AS SHOWN
\odot	VACCINIUM OVATUM	EVERGREEN HUCKLEBERRY	2 GAL.	AS SHOWN
NT MIXES				
SYMBOL	BOTANICAL NAME	COMMON NAME	SIZE	SPACING
1777	FRAGARIA CHILOENSIS	BEACH STRAWBERRY	4" POT	36" O.C.
ليككيا	GAULTHERIA SHALLON	SALAL	1 GAL.	48" O.C.
	ELYMUS MOLLIS	DIME CRACE	DI LIC	45" 0.0
<u>Ministered</u>	FRAGARIA CHILOENSIS	DUNE GRASS BEACH STRAWBERRY	PLUG 4" POT	15" O.C. 48" O.C.
	GRINDELIA INTEGRIFOLIA	PUGET SOUND GUMWEED	PLUG	48" O.C.
	LATHYRUS JAPONICUS	BEACH PEA	4" POT	48" O.C.
44444	FRAGARIA CHILOENSIS	BEACH STRAWBERRY	4* (`·1Ϊ	24" O.C.
المهديما	FRAGARIA VIRGINIANA	WILD STRAWBERRY		
	GAULTHERIA SHALLON	SALAL	4" PO; 1 GAL.	24° O.C. 36° O.C.
(F				
SYMBOL	COMMON NAME			

EXISTING TREES
TO REMAIN, TYP.
FOR TREE PROTECTION
AND FOR EXISTING
TREES, REF.
CIVIL DWGS.

MYRTLE

TYPICAL
GROUNDCOVER


1 SECTOR G TREI


L107) 1"=20'

EXISTING TREES
TO REMAIN, TYP.
FOR TREE PROTECTION
AND FOR EXISTING
TREES, REF.
CIVIL DWGS.

MYRTLE

COORDINATE ROOT BARRIER WITH UNDERGROUND

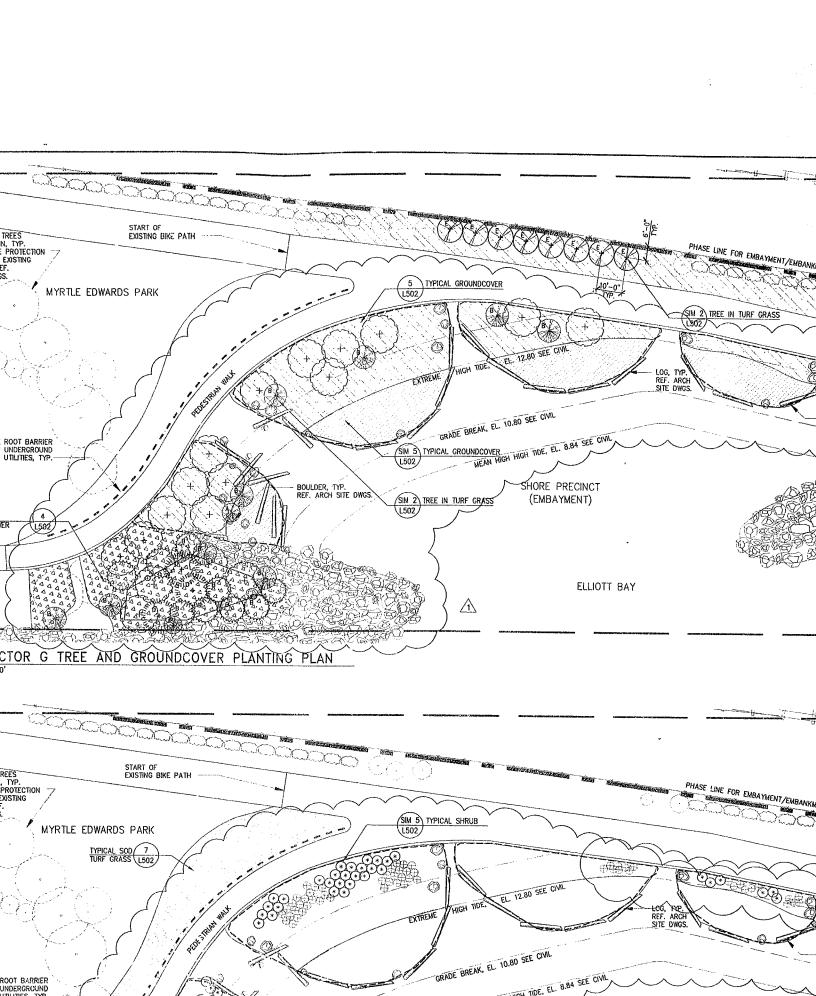

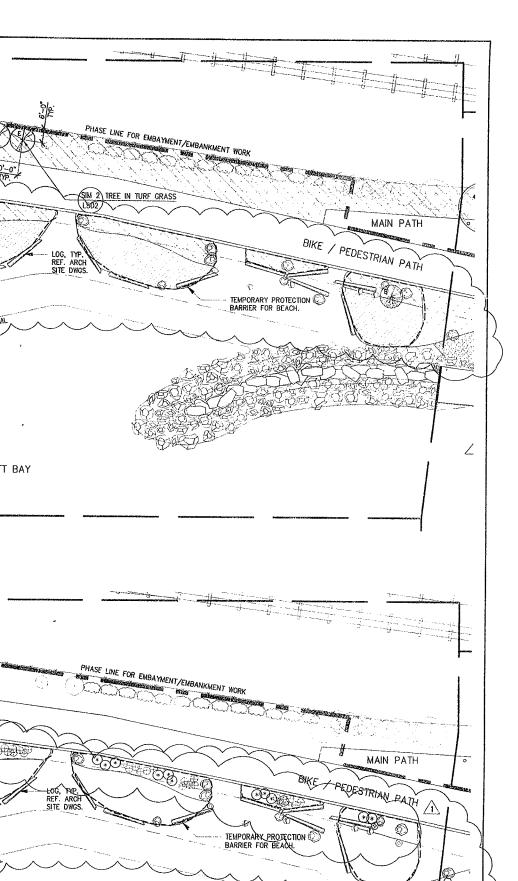

Olympic Sculpture Park

Seattle Art Museum Seattle, Washington 100 University Street Seattle, WA 98101

LEAD DESIGNER Site Design / Architecture Weiss / Manfredi Architects 130 West 29th Street, 12th floor New York, NY 10001 212.760.9002

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Issue Dote Revisions

03.04.05 100% CONSTRUCTION DOCUMENTS

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DRAWING HAS BEEN CLARIFIED W/ NO SCOPE CHANGE, UNLESS OTHERWISE NOTED BY REVISION

Θ	MAHONIA NERVOSA	DULL OREGON GRAPE	2 GAL.	AS SHOWN	2444
⊕ .	ROSA NUTKANA	NOOTKA ROSE	2 GAL.	AS SHOWN	
*	SYMPHORICARPOS ALBUS	SNOWBERRY	2 GAL	AS SHOWN	
⊙	VACCINIUM OVATUM	EVERGREEN HUCKLEBERRY	2 GAL.	AS SHOWN	SECTOR G TREE AND G
PLANT MIXES					
SYMBOL	BOTANICAL NAME	COMMON NAME	SIZE	SPACING	
144.43	FRAGARIA CHILOENSIS	BEACH STRAWBERRY	48 DOT	70 8 0 0	
الـككـكا	GAULTHERIA SHALLON		4" POT	36" O.C.	
	GAULTHERIA SHALLON	SALAL	1 GAL.	48" O.C.	STAF
[200 A	ELYMUS MOLLIS	DUNE GRASS	PLUG	15" O.C.	EXISTING TREES EXIS TO REMAIN, TYP. FOR TREE PROTECTION
	FRAGARIA CHILOENSIS	BEACH STRAWBERRY	4" POT	48" O.C.	AND FOR EXISTING /
	GRINDELIA INTEGRIFOLIA	PUGET SOUND GUMWEED	PLUG	48" O.C.	TREES, REF. CIVIL DWGS.
	LATHYRUS JAPONICUS	BEACH PEA	4" POT	48" O.C.	MYRTLE EDWARDS PA
44444	FRAGARIA CHILOENSIS	BEACH STRAWBERRY	4" 2":T	24" O.C.	TYPICAL SOD TURF GRASS
لمفتيما	FRAGARIA VIRGINIANA	WILD STRAWBERRY	4" PO3	24" O.C.	
	GAULTHERIA SHALLON	SALAL		36" O.C.	・・・ハンナー
TURF	over the second	JACAE	1 GAL.	36 0.0.	
SYMBOL	COMMON NAME				1 4 10
	SOD TURF GRASS				
					COORDINATE ROOT BARRIER WITH UNDERGROUND
PLANTING NOTES: 1. CONTRACTOR SHALL IRRIGA	ATE ALL DROPOSED AND EVISTING DLANT HATERIAL	9. REFER TO SHEET L401 FOR TYPE AND			UTILITIES, TYP.
•	ATE ALL PROPOSED AND EXISTING PLANT MATERIAL CT.	The state of the s	ECINCI BEACH.		
2. CONTRACTOR IS REQUIRED CONTRACTOR SHALL CALL THE (800–424–5555) AT LEAST TV	TO VERIFY UTILITY LOCATIONS PRIOR TO CONSTRU UTILITIES UNDERGROUND LOCATION CENTER WO DAYS PRIOR TO CONSTRUCTION.	ICTION. 11. INSTALL TEMPORARY PROTECTION BA AREAS TO PREVENT ACCESS AND DISTURI REMAIN IN PLACE UNITL GRASS IS WELL E GROWING CONDITION AS APPROVED BY LA	rrier along perimeter of Bance to meadow areas. Stabushed and exhibits A	ALL MEADOW BARRIER SHALL VIGOROUS	TYPICAL SHRUB 5
3. PLANT MATERIALS SHALL IN	MEET STANDARDS SET FORTH IN THE LATEST EDITI NURSERY STOCK (ANSI-Z60.1) AND WASHINGTON	GROWING CONDITION AS APPROVED BY LA ON OF 02930.	NDSCAPE ARCHITECT. REPE	R TO SECTION	L562
STANDARDS FOR NURSERY STO SUFFICIENT ROOT DEVELOPMENT	ICK, ORDER NO. 1627. ALL PLANT MATERIAL SHA' T TO ASSURE SURVIVAL AND HEALTHY GROWTH.	LL HAVE 12. INSTALL TEMPORARY PROTECTION BA AREAS AT SHORE PRECINCT AS SHOWN TO	D PREVENT ACCESS AND DIS		
CONTAINER GROWN PLANT MATE GROWTH TO HOLD THE SOIL IN' NOT BE ROOT BOUND.	ERIALS ARE REQUIRED TO HAVE SUFFICIENT ROOT TACT WHEN REMOVED FROM THE CONTAINER, BUT	PLANTING AREAS. BARRIER SHALL REMAI SHALL ESTABLISHED OR UNTIL REMOVAL IS APPR 2.6 & 3.8.	N IN PLACE UNTIL PLANTS A OVED BY OWNER. REFER TO	RE WELL D SECTION 02930	
	EALTHY AND STRONG CENTRAL LEADERS TO ENSUR	RE 13. INSTALL ROOT BARRIER ALONG PERIN ROOT BARRIER 2-INCHES BELOW FINISH G	ETER OF GROVE AREAS AS	SHOWN. SET	
5. ALIGN ROWS OF TREES, SHRUBS AND GROUNDCOVER TO ADJACENT WALLS. PATHS.		CONSTRUCTION MAY REQUIRE ADJUSTMENT	LATER TO ENSURE FINAL L	OCATION IS	
AND GRADE BREAKS UNLESS OTHERWISE NOTED. 6. ALL DIMENSIONS ARE TO CENTER OF TREE UNLESS OTHERWISE NOTED.		14. REFER TO CIVIL DWGS, FOR LAYOUT, FOR STREET TREES.	QUANTITIES, SPECIES AND P	LANTING DETAIL	
7. REFER TO TYPICAL PLANTING DETAILS FOR SHRUBS, GROUNDCOVER, SOD TURF GRASS, MEADOW GRASS AND PLUGS ON SHEET 1.502 UNLESS OTHERWISE NOTED.		F 15. REFER TO CIVIL/ARCH, SITE DWGS, F ELEMENTS AND FOR GRADING.	OR LAYOUT OF SITE WALLS		
	MASTER PLANT SCHEDULE AND FIELD LOCATED P		PROTECTION, REFER TO SHIT	L502 FOR TREE	
		17. NO PESTICIDES, HERBICIDES OR CHEM VEGETATION AT THE SHORE PRECINCT.	ICAL FERTILIZERS SHOULD B	E APPLIED TO	2 SECTOR G SHRUB, TURF
	FOR ADVERTISING: th J. Nakatsu				ASTINUTES.
		EVIEWED:		Charles Anderso	on Landscape Architecture

Seattle, Washington____

Director, Contracting Services Division

PARK ENGINEER


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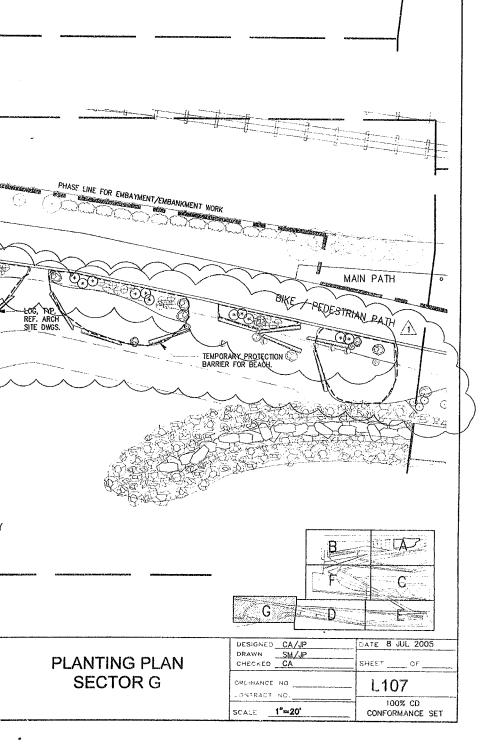
All work done in accordance with the City of Seattle Standard Plans and Specifications in effect on the date shown above, and supplemented by Special Provisions.

83 Columbia \$1 Suite 301 Seattle, WA 98104 T 206-516-4200 F 206-516-4201 http://www.chartesonderson.com



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issue Date

03.04.05 100% CONSTRUCTION DOCUMENTS

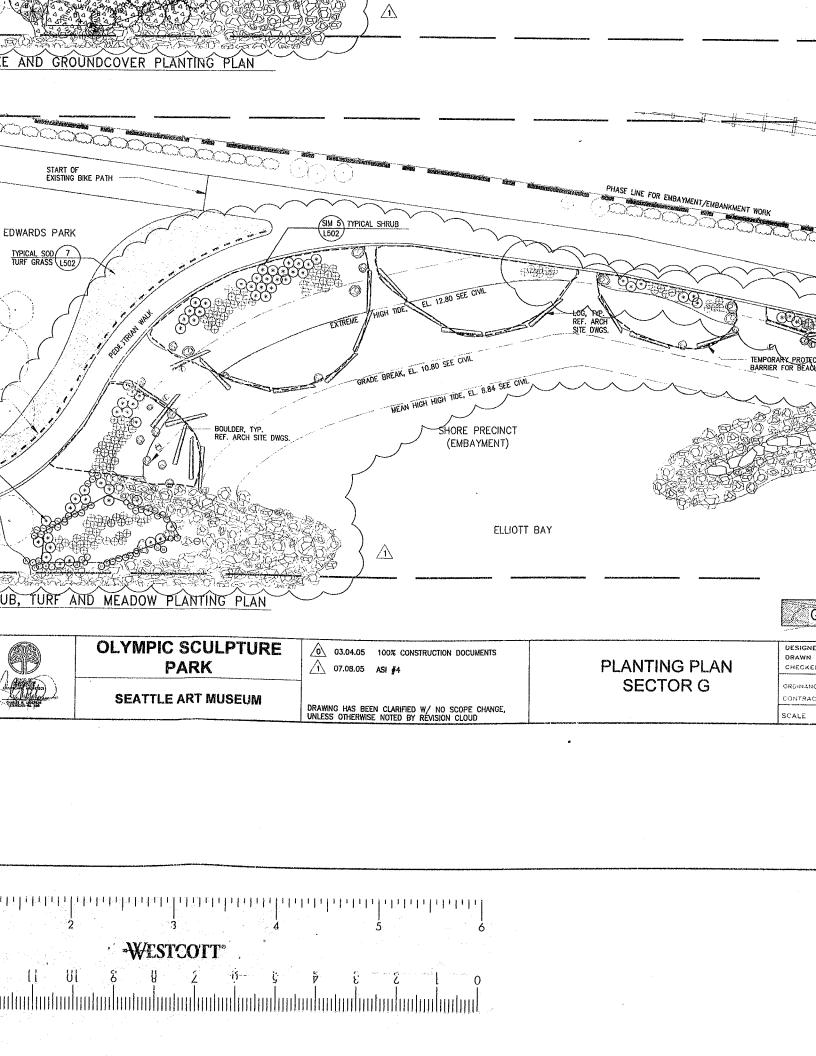1 07.08.05 ASI #4

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DRAWING TITLE

PLANTING PLAN SECTOR G

Drawn SM/JP Date JULY 8, 2005 Checked CA Scale 1" = 20"





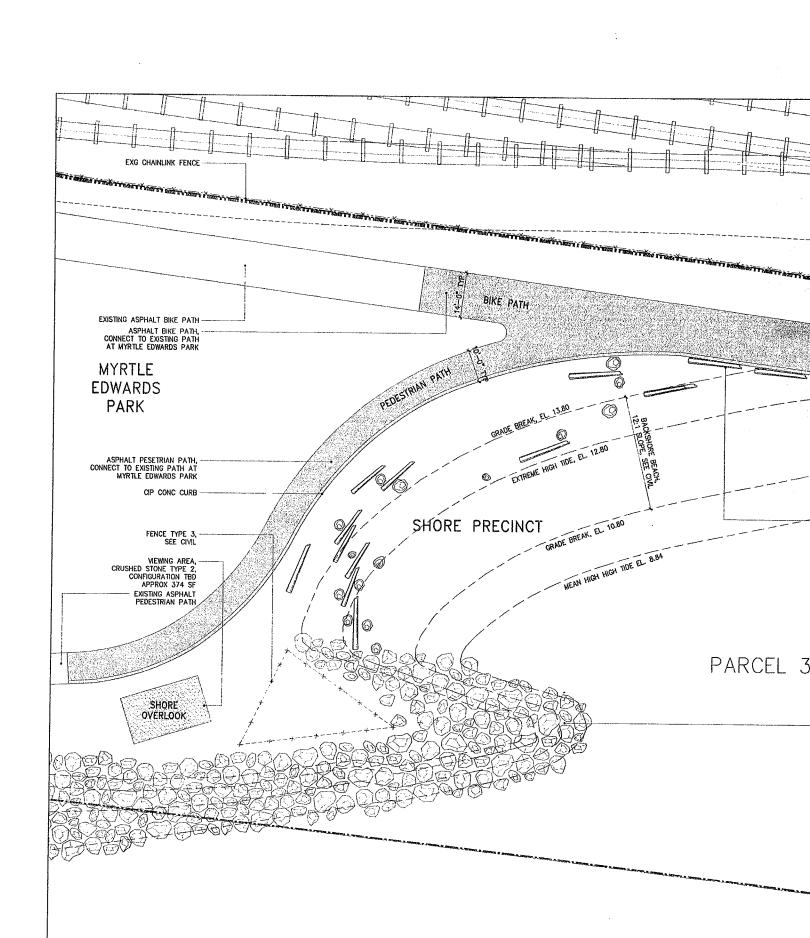


EXHIBIT D Embayment Plan

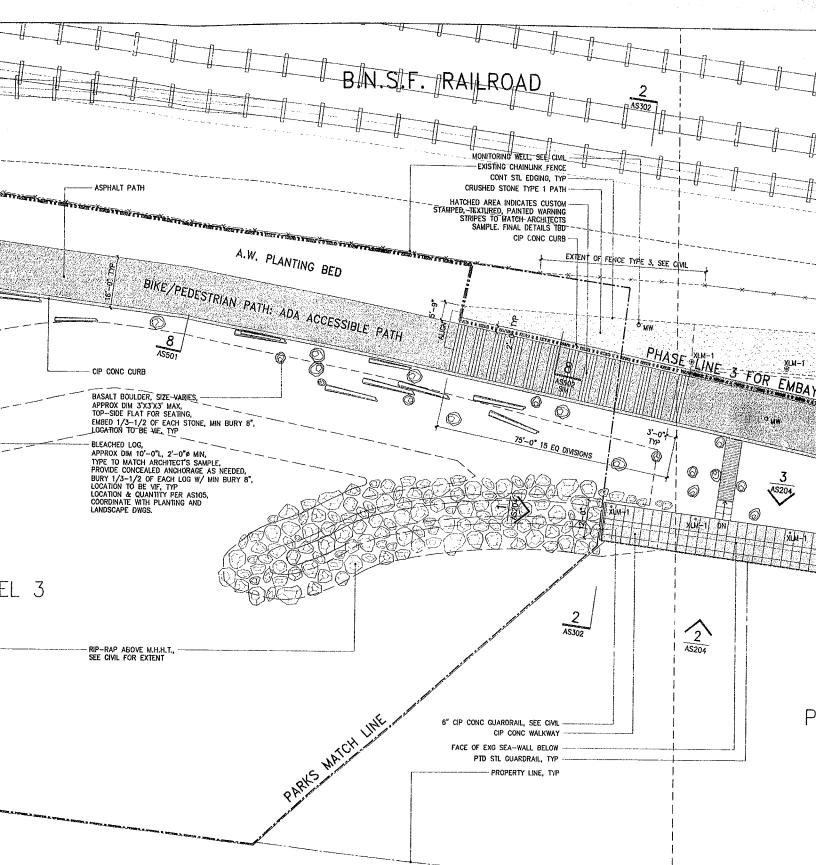

HIBIT D yment Plan

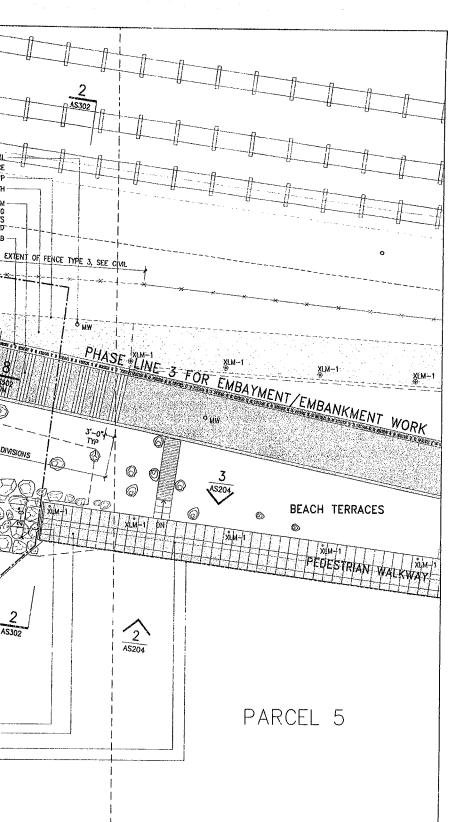

Olympic Sculpture Park

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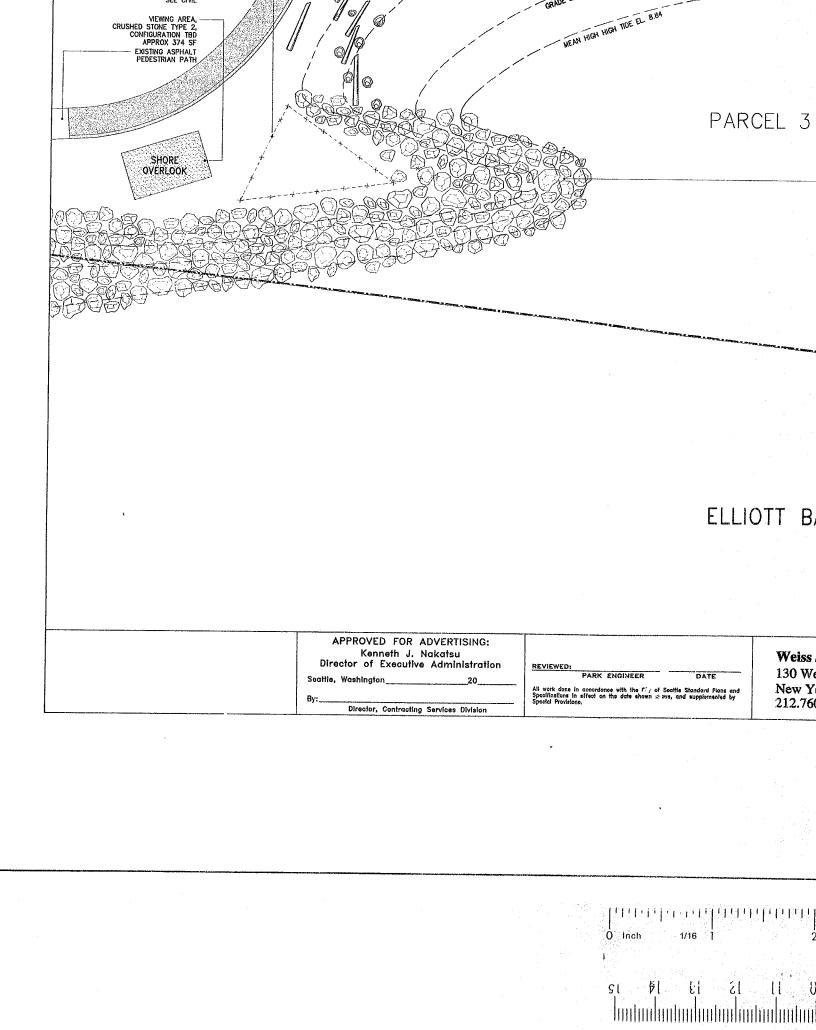
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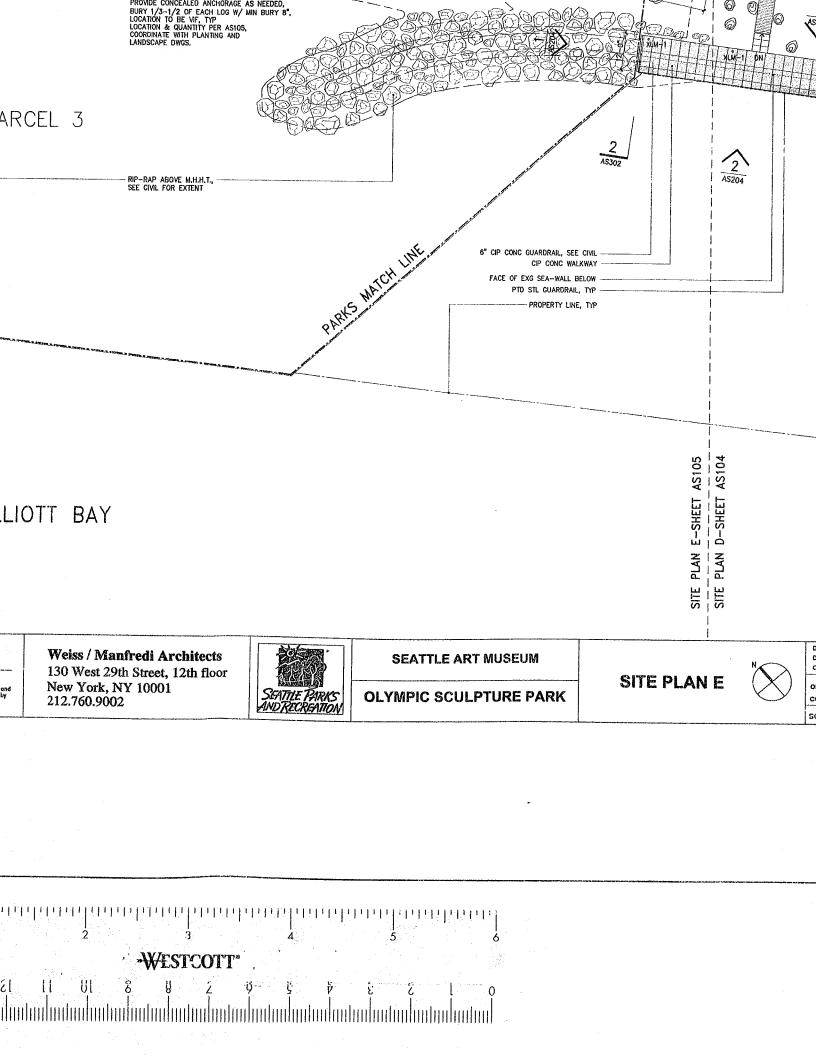
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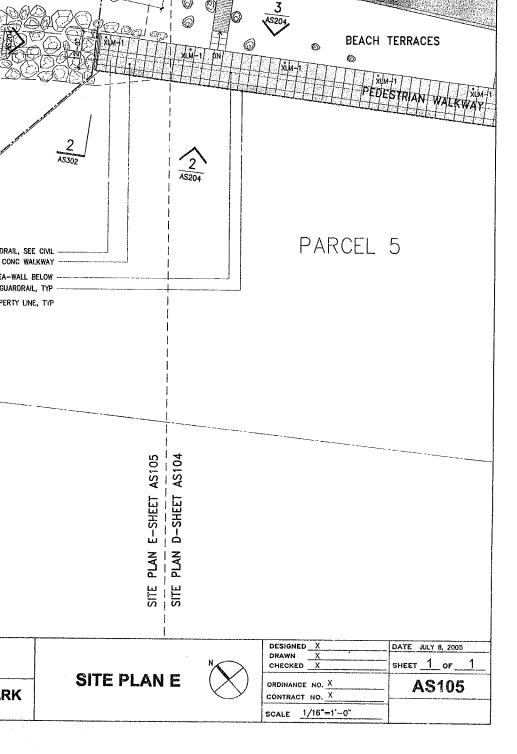
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Issue	Oote	Revisions
\triangle	03.04.05	100% CONSTRUCTION COCUMNTS
$\overline{\mathbf{U}}$	07.08.05	ASI #4

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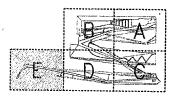
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CRUSHED STONE PATH TYPE 1
CRUSHED STONE PATH TYPE 2
FIBAN PATH
CRUSHED STONE BASE STRIP
CONCRETE PAVING
CONCRETE PAVING
GRADE BREAK
SITCL EDGING
PHASE MATCHLINE
PROGRAM, N.I.C.
PROPERTY LINE



DRAWING TITLE

SITE PLAN E

Drawn -- Date JULY 8, 2005

Checked -- Scale 1/16" = 1'-0"

Drawing No.

AS105



